



## **AMERICAN TOWER®**

ATC SITE NAME: PARLIN - SAYREVILLE

ATC SITE NUMBER: 373155 AT&T SEARCH RING: W-5836

AT&T PACE NUMBER: MRNYJ007953,

MRNYJ011805, MRNYJ011801, MRNYJ011847

AT&T SITE ID: NWL05836 AT&T FA CODE:14652316

AT&T SITE NAME: PARLIN - NYCWNJ5836 SITE ADDRESS: 775 WASHINGTON ROAD PARLIN, NJ 08859-0000



**LOCATION MAP** 

AT&T			MOBILITY COLOCATION PLAN		SHEET INDEX			
COMPLIANCE CODE	PROJECT S	SUMMARY	PROJECT DESCRIPTION	SHEET NO:	DESCRIPTION:	REV:	DATE:	BY:
ALL WORK SHALL BE PERFORMED AND MATERIALS INSTALLED	SITE ADDRESS:			G-001	TITLE SHEET	0	09/01/2021	ТММ
IN ACCORDANCE WITH THE CURRENT EDITIONS OF THE FOLLOWING CODES AS ADOPTED BY THE LOCAL	775 WASHING	STON ROAD	THE PROPOSED PROJECT INCLUDES INSTALLING	G-002	GENERAL NOTES	0	09/01/2021	TMM
GOVERNMENT AUTHORITIES. NOTHING IN THESE PLANS IS TO BE CONSTRUED TO PERMIT WORK NOT CONFORMING TO	PARLIN, NJ 08859-0000		EQUIPMENT CABINETS AND A GENERATOR ON A PROPOSED CONCRETE PAD INSIDE A 10' X 30' GROUND SPACE WITHIN	C-001	OVERALL SITE PLAN	0	09/01/2021	TMM
THESE CODES.	COUNTY: MI	DDLESEX	THE EXISTING COMPOUND, AND INSTALLING NEW EQUIPMENT AND MOUNTS ON THE EXISTING TOWER.	C-101	DETAILED SITE PLAN	0	09/01/2021	TMM
2018 INTERNATIONAL BUILDING CODE (IBC), NEW JERSEY     EDITION	GEOGRAPHIC CO	OORDINATES:		C-102	DETAILED EQUIPMENT LAYOUT	0	09/01/2021	TMM
2. 2017 NATIONAL ELECTRIC CODE (NEC)	LATITUDE: 40			C-201	TOWER ELEVATION	0	09/01/2021	TMM
LOCAL BUILDING CODE     CITY/COUNTY ORDINANCES	LONGITUDI GROUND ELEVAT			C-401	ANTENNA INFORMATION & SCHEDULE	0	09/01/2021	TMM
	ONOOND ELEVAT	TON. 114 AWOL		C-501	MOUNT DETAILS	0	09/01/2021	TMM
			PROJECT NOTES	C-502	CONSTRUCTION DETAILS	0	09/01/2021	TMM
			THE FACILITY IS UNMANNED.	C-503	CONSTRUCTION DETAILS	0	09/01/2021	TMM
	PROJECT TEAM	A TECHNICIAN WILL VISIT THE SITE APPROXIMATELY ONCE     A MONTH FOR ROUTINE INSPECTION AND MAINTENANCE.	C-504	CONSTRUCTION DETAILS	0	09/01/2021	TMM	
			C-505	GENERATOR SPECIFICATIONS	0	09/01/2021	TMM	
	AMERICAN TOWER AT 10 PRESIDENTIAL WAY	APPLICANT:	3. THE PROJECT WILL NOT RESULT IN ANY SIGNIFICANT LAND DISTURBANCE OR EFFECT OF STORM WATER DRAINAGE.  4. NO SANITARY SEWER, POTABLE WATER OR TRASH	E-101	GROUNDING DETAILS & ELECTRICAL SCHEMATIC	0	09/01/2021	TMM
		AT&T MOBILITY		E-102	GROUNDING DETAIL	0	09/01/2021	TMM
UTILITY COMPANIES	WOBURN, MA 01801		DISPOSAL IS REQUIRED.	E-501	GROUNDING DETAILS	0	09/01/2021	TMM
POWER COMPANY: FIRST ENERGY COS	ENGINEER:		5. HANDICAP ACCESS IS NOT REQUIRED.	E-601	PANEL SCHEDULE	0	09/01/2021	TMM
PHONE: (888) 544-4877	RPM ENGINEERING LLC 139 East Chestnut Street			R-601	SUPPLEMENTAL			
TELEPHONE COMPANY: VERIZON PHONE: (800) 837-4966	Coatesville PA 19320		PROJECT LOCATION DIRECTIONS	R-602	SUPPLEMENTAL			
PHONE. (600) 657-4900	PROPERTY OWNER:			R-603	SUPPLEMENTAL			
811.	COLUMBUS CLUB 775 WASHINGTON ROAD - PARLIN - NJ - 08859		R-604	SUPPLEMENTAL				
		FROM NORTH JERSEY/NY AREA -TAKE NJ TURNPIKE SOUTH TO ROUTE 9 SOUTH TO ERNSTON RD WEST TO WASHINGTON	R-605	SUPPLEMENTAL				
	AMERICAN TOWER 116 HUNTINGTON AVE		MAKE RIGHT ,MAKE A RIGHT ON SHREE TOWARD HISH TEMPLE. TOWER IS ON RIGHT.	R-606	SUPPLEMENTAL			
Know what's below.	BOSTON, MA 02116			R-607	SUPPLEMENTAL			
Call before you dig.				R-608	SUPPLEMENTAL			




ATC SITE NUMBER: 373155

ATC SITE NAME: PARLIN - SAYREVILLE

AT&T MOBILITY SITE NAME:

PARLIN - NYCWNJ5836

SITE ADDRESS: 775 WASHINGTON ROAD

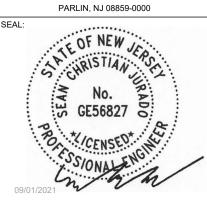



DATE DRAWN:	01/20/21
ATC JOB NO:	13325346_G2
CUSTOMER ID:	NWL05836
CUSTOMER #:	14652316

TITLE SHEET

REVISION: G-001

0

## **GENERAL CONSTRUCTION NOTES:**

- OWNER FURNISHED MATERIALS, AT&T MOBILITY "THE COMPANY" WILL PROVIDE AND THE 22. CONTRACTOR WILL INSTALL
  - A. BTS EQUIPMENT FRAME (PLATFORM) AND ICEBRIDGE SHELTER (GROUND
  - BUILD/CO-LOCATE ONLY) AC/TELCO INTERFACE BOX (PPC)
  - C. ICE BRIDGE (CABLE TRAY WITH COVER) (GROUND BUILD/CO-LOCATE ONLY, GC TO FURNISH AND INSTALL FOR ROOFTOP INSTALLATION)
  - D. TOWERS, MONOPOLES
  - TOWER LIGHTING
  - GENERATORS & LIQUID PROPANE TANK
  - ANTENNA STANDARD BRACKETS, FRAMES AND PIPES FOR MOUNTING
  - ANTENNAS (INSTALLED BY OTHERS)
  - TRANSMISSION LINE
  - TRANSMISSION LINE JUMPERS
  - TRANSMISSION LINE CONNECTORS WITH WEATHERPROOFING KITS
  - TRANSMISSION LINE GROUND KITS
  - HANGERS
  - HOISTING GRIPS
  - O. BTS EQUIPMENT
- THE CONTRACTOR IS RESPONSIBLE TO PROVIDE ALL OTHER MATERIALS FOR THE MATERIALS AS FENCING, STRUCTURAL STEEL SUPPORTING SUB-FRAME FOR PLATFORM ROOFING LABOR AND MATERIALS GROUNDING RINGS GROUNDING WIRES COPPER-CLAD OR XIT CHEMICAL GROUND ROD(S), BUSS BARS, TRANSFORMERS AND DISCONNECT SWITCHES WHERE APPLICABLE, TEMPORARY ELECTRICAL POWER. CONDUIT LANDSCAPING COMPOUND STONE, CRANES, CORE DRILLING, SLEEPERS AND RUBBER MATTING, REBAR, CONCRETE CAISSONS, PADS AND/OR AUGER MOUNTS, MISCELLANEOUS FASTENERS, CABLE TRAYS, NON-STANDARD ANTENNA FRAMES AND ALL OTHER MATERIAL AND LABOR REQUIRED TO COMPLETE THE JOB ACCORDING TO THE DRAWINGS AND SPECIFICATIONS. IT IS THE POSITION OF AT&T MOBILITY TO APPLY FOR PERMITTING AND CONTRACTOR RESPONSIBLE FOR PICKUP AND PAYMENT OF
- ALL WORK SHALL CONFORM TO ALL CURRENT APPLICABLE FEDERAL, STATE, AND LOCAL CODES, INCLUDING ANSI/EIA/TIA-222, AND COMPLY WITH ATC CONSTRUCTION
- CONTRACTOR SHALL CONTACT LOCAL 811 FOR IDENTIFICATION OF UNDERGROUND UTILITIES PRIOR TO START OF CONSTRUCTION.
- CONTRACTOR SHALL BE RESPONSIBLE FOR COORDINATING ALL REQUIRED INSPECTIONS.
- ALL DIMENSIONS TO, OF, AND ON EXISTING BUILDINGS, DRAINAGE STRUCTURES, AND SITE IMPROVEMENTS SHALL BE VERIFIED IN FIELD BY CONTRACTOR WITH ALL DISCREPANCIES REPORTED TO THE ENGINEER.
- DO NOT CHANGE SIZE OR SPACING OF STRUCTURAL ELEMENTS
- DETAILS SHOWN ARE TYPICAL; SIMILAR DETAILS APPLY TO SIMILAR CONDITIONS UNLESS 32.
- THESE DRAWINGS DO NOT INCLUDE NECESSARY COMPONENTS FOR CONSTRUCTION SAFETY WHICH SHALL BE THE SOLE RESPONSIBILITY OF THE CONTRACTOR
- CONTRACTOR SHALL BRACE STRUCTURES UNTIL ALL STRUCTURAL ELEMENTS NEEDED FOR STABILITY ARE INSTALLED. THESE ELEMENTS ARE AS FOLLOWS: LATERAL BRACING,
- CONTRACTOR SHALL DETERMINE EXACT LOCATION OF EXISTING UTILITIES, GROUNDS DRAINS, DRAIN PIPES, VENTS, ETC, BEFORE COMMENCING WORK
- INCORRECTLY FABRICATED, DAMAGED, OR OTHERWISE MISFITTING OR NONCONFORMING MATERIALS OR CONDITIONS SHALL BE REPORTED TO THE AT&T MOBILITY REP PRIOR TO REMEDIAL OR CORRECTIVE ACTION, ANY SUCH REMEDIAL ACTION SHALL REQUIRE WRITTEN APPROVAL BY THE AT&T MOBILITY REP PRIOR TO
- EACH CONTRACTOR SHALL COOPERATE WITH THE AT&T MOBILITY REP, AND COORDINATE HIS WORK WITH THE WORK OF OTHERS
- CONTRACTOR SHALL REPAIR ANY DAMAGE CAUSED BY CONSTRUCTION OF THIS PROJECT TO MATCH EXISTING PRE-CONSTRUCTION CONDITIONS TO THE SATISFACTION OF THE AT&T MOBILITY CONSTRUCTION MANAGER.
- ALL CARLE/CONDUIT ENTRY/EXIT PORTS SHALL BE WEATHERPROOFED DURING INSTALLATION USING A SILICONE SEALANT
- WHERE EXISTING CONDITIONS DO NOT MATCH THOSE SHOWN IN THIS PLAN SET, CONTRACTOR SHALL NOTIFY THE AT&T MOBILITY REP AND ENGINEER OF RECORD IMMEDIATELY
- CONTRACTOR SHALL ENSURE ALL SUBCONTRACTORS ARE PROVIDED WITH A COMPLETE AND CURRENT SET OF DRAWINGS AND SPECIFICATIONS FOR THIS PROJECT.
- CONTRACTOR SHALL REMOVE ALL RUBBISH AND DEBRIS FROM THE SITE AT THE END OF  $\phantom{-}3$ .
- CONTRACTOR SHALL COORDINATE WORK SCHEDULE WITH AMERICAN TOWER CORPORATION (ATC) AND TAKE PRECAUTIONS TO MINIMIZE IMPACT AND DISRUPTION OF OTHER OCCUPANTS OF THE FACILITY.
- CONTRACTOR SHALL FURNISH AT&T MOBILITY AND AMERICAN TOWER CORPORATION (ATC) WITH A PDF MARKED UP AS-BUILT SET OF DRAWINGS UPON COMPLETION OF
- PRIOR TO SUBMISSION OF BID, CONTRACTOR SHALL COORDINATE WITH AT&T MOBILITY REP TO DETERMINE WHAT, IF ANY, ITEMS WILL BE PROVIDED. ALL ITEMS NOT PROVIDED SHALL BE PROVIDED AND INSTALLED BY THE CONTRACTOR. CONTRACTOR WILL INSTALL

- ALL ITEMS PROVIDED.
- PRIOR TO SUBMISSION OF BID. CONTRACTOR SHALL COORDINATE WITH AT&T MOBILITY REP TO DETERMINE IF ANY PERMITS WILL BE OBTAINED BY CONTRACTOR. ALL
  REQUIRED PERMITS NOT OBTAINED BY AT&T MOBILITY MUST BE OBTAINED, AND PAID FOR, BY THE CONTRACTOR
- 23. CONTRACTOR SHALL INSTALL ALL SITE SIGNAGE IN ACCORDANCE WITH AT&T MOBILITY SPECIFICATIONS AND REQUIREMENTS.
- CONTRACTOR SHALL SUBMIT ALL SHOP DRAWINGS TO AT&T MOBILITY FOR REVIEW AND APPROVAL PRIOR TO FABRICATION.
- 25. ALL EQUIPMENT SHALL BE INSTALLED ACCORDING TO MANUFACTURER'S SPECIFICATIONS AND LOCATED ACCORDING TO AT&T MOBILITY SPECIFICATIONS, AND AS SHOWN IN THESE PLANS.
- 26. THE CONTRACTOR SHALL SUPERVISE AND DIRECT THE PROJECT DESCRIBED HEREIN. THE CONTRACTOR SHALL BE SOLELY RESPONSIBLE FOR ALL THE CONSTRUCTION MEANS, METHODS, TECHNIQUES, SEQUENCES AND PROCEDURES AND FOR COORDINATING ALL PORTIONS OF THE WORK UNDER THE CONTRACT.
- CONTRACTOR SHALL NOTICY AT&T MORILITY, REP & MINIMUM OF 48 HOLIRS IN ADVANCE OF POURING CONCRETE OR BACKFILLING ANY UNDERGROUND UTILITIES, FOUNDATIONS OR SEALING ANY WALL, FLOOR OR ROOF PENETRATIONS FOR ENGINEERING REVIEW
- CONTRACTOR SHALL BE RESPONSIBLE FOR SITE SAFETY INCLUDING COMPLIANCE WITH ALL APPLICABLE OSHA STANDARDS AND RECOMMENDATIONS AND SHALL PROVIDE ALL NECESSARY SAFETY DEVICES INCLUDING PPE AND PPM AND CONSTRUCTION DEVICES SUCH AS WELDING AND FIRE PREVENTION, TEMPORARY SHORING, SCAFFOLDING, TRENCH BOXES/SLOPING, BARRIERS, ETC.
- THE CONTRACTOR SHALL PROTECT AT HIS OWN EXPENSE, ALL EXISTING FACILITIES AND SUCH OF HIS NEW WORK LIABLE TO INJURY DURING THE CONSTRUCTION PERIOD. ANY DAMAGE CAUSED BY NEGLECT ON THE PART OF THIS CONTRACTOR OR HIS REPRESENTATIVES, OR BY THE ELEMENTS DUE TO NEGLECT ON THE PART OF THIS CONTRACTOR OR HIS REPRESENTATIVES. FITHER TO THE EXISTING WORK, OR TO HIS WORK OR THE WORK OF ANY OTHER CONTRACTOR, SHALL BE REPAIRED AT HIS EXPENSE TO THE OWNER'S SATISFACTION.
- 30. ALL WORK SHALL BE INSTALLED IN A FIRST CLASS. NEAT AND WORKMANLIKE MANNER BY MECHANICS SKILLED IN THE TRADE INVOLVED. THE QUALITY OF WORKMANSHIP SHALL BE SUBJECT TO THE APPROVAL OF THE AT&T MOBILITY REP. ANY WORK FOUND BY THE AT&T MOBILITY, REP TO BE OF INFERIOR QUALITY AND/OR WORKMANSHIP SHALL BE REPLACED AND/OR REWORKED AT CONTRACTOR EXPENSE UNTIL APPROVAL IS
- IN ORDER TO ESTABLISH STANDARDS OF QUALITY AND PERFORMANCE, ALL TYPES OF MATERIALS LISTED HEREINAETER BY MANUFACTURER'S NAMES AND/OF MANUFACTURER'S CATALOG NUMBER SHALL BE PROVIDED BY THESE MANUFACTURERS
- AT&T MOBILITY FURNISHED EQUIPMENT SHALL BE PICKED-UP AT THE AT&T MOBILITY WAREHOUSE, NO LATER THAN 48HR AFTER BEING NOTIFIED INSURED, STORED, UNCRATE, PROTECTED AND INSTALLED BY THE CONTRACTOR WITH ALL APPURTENANCES REQUIRED TO PLACE THE EQUIPMENT IN OPERATION, READY FOR USE. THE CONTRACTOR SHALL BE RESPONSIBLE FOR THE EQUIPMENT AFTER PICKING IT
- AT&T MOBILITY OR HIS ARCHITECT/ENGINEER RESERVES THE RIGHT TO REJECT ANY FOLIPMENT OR MATERIALS WHICH, IN HIS OWN OPINION ARE NOT IN COMPLIANCE WITH THE CONTRACT DOCUMENTS, EITHER BEFORE OR AFTER INSTALLATION AND THE EQUIPMENT SHALL BE REPLACED WITH EQUIPMENT CONFORMING TO THE REQUIREMENTS OF THE CONTRACT DOCUMENTS BY THE CONTRACTOR AT NO COST TO AT&T MOBILITY OR THEIR ARCHITECT/ENGINEER

## STRUCTURAL STEEL NOTES:

- STRUCTURAL STEEL SHALL CONFORM TO THE LATEST EDITION OF THE AISC "SPECIFICATION FOR THE DESIGN, FABRICATION AND ERECTION OF STRUCTURAL STEEL
- STRUCTURAL STEEL ROLLED SHAPES, PLATES AND BARS SHALL CONFORM TO THE FOLLOWING ASTM DESIGNATIONS:
  - A. ASTM A-572, GRADE 50 ALL W SHAPES, UNLESS NOTED OR A992 OTHERWISE
  - B. ASTM A-36 ALL OTHER ROLLED SHAPES, PLATES AND BARS UNLESS NOTED
  - C. ASTM A-500, GRADE B HSS SECTION (SQUARE, RECTANGULAR, AND ROUND)
  - D. ASTM A-325, TYPE SC OR N ALL BOLTS FOR CONNECTING STRUCTURAL
  - E. ASTM F-1554 07 ALL ANCHOR BOLTS, UNLESS NOTED OTHERWISE
- ALL EXPOSED STRUCTURAL STEEL MEMBERS SHALL BE HOT-DIPPED GALVANIZED AFTER FABRICATION PER ASTM A123. EXPOSED STEEL HARDWARE AND ANCHOR BOLTS SHALL BE GALVANIZED PER ASTM A153 OR B695.
- ALL FIELD CUT SURFACES. FIELD DRILLED HOLES AND GROUND SURFACES WHERE EXISTING PAINT OR GALVANIZATION REMOVAL WAS REQUIRED SHALL BE REPAIRED WITH (2) BRUSHED COATS OF ZRC GALVILITE COLD GALVANIZING COMPOUND PER ASTM A780.
- DO NOT DRILL HOLES THROUGH STRUCTURAL STEEL MEMBERS EXCEPT AS SHOWN AND DETAILED ON STRUCTURAL DRAWINGS
- CONNECTIONS:

- A. ALL WELDING TO BE PERFORMED BY AWS CERTIFIED WELDERS AND CONDUCTED IN ACCORDANCE WITH THE LATEST EDITION OF THE AWS WELDING
- B. ALL WELDS SHALL BE INSPECTED VISUALLY, 25% OF WELDS SHALL BE INSPECTED WITH DYE PENETRANT OR MAGNETIC PARTICLE TO MEET THE ACCEPTANCE CRITERIA OF AWS D1.1. REPAIR ALL WELDS AS NECESSARY.
- C. INSPECTION SHALL BE PERFORMED BY AN AWS CERTIFIED WELD INSPECTOR.
- D. IT IS THE CONTRACTORS RESPONSIBILITY TO PROVIDE BURNING/WELDING SHALL HAVE FIRE DEPARTMENT DETAIL FOR ANY WELDING ACTIVITY.
- E. ALL ELECTRODES TO BE LOW HYDROGEN, MATCHING FILLER METAL, PER AWS D1.1, UNLESS NOTED OTHERWISE
- F. MINIMUM WELD SIZE TO BE 0.1875 INCH FILLET WELDS, UNLESS NOTED
- G. PRIOR TO FIELD WELDING GALVANIZING MATERIAL. CONTRACTOR SHALL GRIND OFF GALVANIZING '%" BEYOND ALL FIELD WELD SURFACES. AFTER WELD AND WELD INSPECTION IS COMPLETE, REPAIR ALL GROUND AND WELDED SURFACES WITH ZRC GALVILITE COLD GALVANIZING COMPOUND PER ASTM A780 AND MANUFACTURERS RECOMMENDATIONS.
- THE CONTRACTOR SHALL PROVIDE ADEQUATE SHORING AND/OR BRACING WHERE REQUIRED DURING CONSTRUCTION UNTIL ALL CONNECTIONS ARE
- ANY FIELD CHANGES OR SUBSTITUTIONS SHALL HAVE PRIOR APPROVAL FROM

## SPECIAL CONSTRUCTION ANTENNA INSTALLATION NOTES:

- - ANTENNA AND COAXIAL CABLES ARE FURNISHED BY AT&T MOBILITY UNDER A SEPARATE CONTRACT. THE CONTRACTOR SHALL ASSIST ANTENNA INSTALLATION CONTRACTOR IN TERMS OD COORDINATION AND SITE ACCESS. ERECTION SUBCONTRACTOR SHALL BE RESPONSIBLE FOR THE PROTECTION OF
  - B. INSTALL ANTENNA AS INDICATE ON DRAWINGS AND AT&T MOBILITY
  - C. INSTALL GALVANIZED STEEL ANTENNA MOUNTS AS INDICATED ON DRAWINGS
  - D. INSTALL FURNISHED GALVANIZED STEEL OR ALUMINUM WAVEGUIDE AND PROVIDE PRINTOUT OF THAT TEST.
  - E. CONTRACTOR SHALL PROVIDE FOUR (4) SETS OF SWEEP TESTS LISING ANRITZU-PACKARD 8713B RF SCALAR NETWORK ANALYZER. SUBMIT FREQUENCY DOMAIN REFLECTOMETER(FDR) TESTS RESULTS TO THE PROJECT MANAGER. SWEEP TESTS SHALL BE AS PER ATTACHED RFS "MINIMUM FIELD TESTING RECOMMENDED FOR ANTENNA AND HELIAX COAXIAL CABLE SYSTEMS" DATED 10/5/93, TESTING SHALL BE PERFORMED BY AN INDEPENDENT TESTING SERVICE AND BE BOUND AND SUBMITTED WITHIN ONE WEEK OF WORK COMPLETION.
  - INSTALL COAXIAL CABLES AND TERMINATING BETWEEN ANTENNAS AND EQUIPMENT PER MANUFACTURER'S RECOMMENDATIONS. WEATHERPROOF ALL CONNECTIONS RETWEEN THE ANTENNA AND FOLIPMENT PER MANUFACTURER'S REQUIREMENTS. TERMINATE ALL COAXIAL CABLE THREE (3) FEET IN EXCESS OF ENTRY PORT LOCATION UNLESS OTHERWISE STATED.
  - G. ANTENNA AND COAXIAL CABLE GROUNDING:
- ALL EXTERIOR #6 GREED GROUND WIRE "DAISY CHAIN" CONNECTIONS ARE TO BE WEATHER SEALED WITH RFS CONNECTORS/SPLICE WEATHERPROOFING KIT #221213 OR
- ALL COAXIAL CABLE GROUNDING KITS ARE TO BE INSTALLED ON STRAIGHT RUNS OF COAXIAL CABLE (NOT WITHIN BENDS)

## CONCRETE AND REINFORCING STEEL NOTES:

- DESIGN AND CONSTRUCTION OF ALL CONCRETE ELEMENTS SHALL CONFORM TO THE LATEST EDITIONS OF ALL APPLICABLE CODES INCLUDING: ACI 301 "SPECIFICATIONS FOR STRUCTURAL CONCRETE FOR BUILDINGS", ACI 117 "SPECIFICATIONS FOR TOLERANCES FOR CONCRETE CONSTRUCTION AND MATERIALS", AND ACI 318 "BUILDING CODE REQUIREMENTS FOR REINFORCED CONCRETE."
- 2. MIX DESIGN SHALL BE APPROVED BY AT&T MOBILITY REP PRIOR TO PLACING
- CONCRETE SHALL BE NORMAL WEIGHT, 6 % AIR ENTRAINED (+/- 1.5%) WITH A SLUMF RANGE OF 3-6" AND HAVE A MINIMUM 28-DAY COMPRESSIVE STRENGTH OF 4000 PSI
- THE FOLLOWING MATERIALS SHALL BE USED:

NORMAL WEIGHT AGGREGATE:

PORTLAND CEMENT: ASTM C150, TYPE 2

REINFORCEMENT: ASTM A185, PLAIN STEEL WELDED WIRE FABRIC REINFORCEMENT BARS: ASTM A615, GRADE 60, DEFORMED

ASTM C33

WATER: ASTM C 94/C 94M WELDED WIRE FABRIC:

ADMIXTURES:

-WATER-REDUCING AGENT: ASTM C 494/C 494M, TYPE A

-AIR-ENTERING AGENT: ASTM C 260/C 260M

-SUPERPLASTICIZER ASTM C494, TYPE F OR TYPE G -RETARDING: ASTM C 494/C 494M, TYPE B

- MINIMUM CONCRETE COVER FOR REINFORCING STEEL SHALL BE NO LESS THAN 3".
- A 3/4" CHAMFER SHALL BE PROVIDED AT ALL EXPOSED EDGES OF CONCRETE IN ACCORDANCE WITH ACI 301 SECTION 4.2.4, UNLESS NOTED OTHERW
- INSTALLATION OF CONCRETE EXPANSION/WEDGE ANCHOR SHALL BE PER MANUFACTURER'S WRITTEN RECOMMENDED PROCEDURE. THE ANCHOR BOLT, DOWEL OR ROD SHALL CONFORM TO MANUFACTURER'S RECOMMENDATION FOR EMBEDMENT TH OR AS SHOWN ON THE DRAWINGS. NO REBAR SHALL BE CUT WITHOUT PRIOR APPROVAL FROM AN ATC ENGINEER WHEN DRILLING HOLES IN CONCRETE
- ADMIXTURES SHALL CONFORM TO THE APPROPRIATE ASTM STANDARD AS REFERENCED
- DO NOT WELD OR TACK WELD REINFORCING STEEL.
- ALL DOWELS, ANCHOR BOLTS, EMBEDDED STEEL, ELECTRICAL CONDUITS, PIPE SLEEVES, GROUNDS AND ALL OTHER EMBEDDED ITEMS AND FORMED DETAILS SHALL BE IN PLACE BEFORE START OF CONCRETE PLACEMENT.
- REINFORCEMENT SHALL BE COLD BENT WHENEVER BENDING IS REQUIRED.
- 12. DO NOT PLACE CONCRETE IN WATER, ICE, OR ON FROZEN GROUND.
- FOR COLD-WEATHER (ACI 306) AND HOT-WEATHER (ACI 301M) CONCRETE PLACEMENT CONFORM TO APPLICABLE ACI CODES AND RECOMMENDATIONS. IN EITHER CASE, MATERIALS CONTAINING CHLORIDE, CALCIUM, SALTS, ETC. SHALL NOT BE USED. PROTECT FRESH CONCRETE FROM WEATHER FOR 7 DAYS, MINIMUM.
- ALL CONCRETE SHALL HAVE A "SMOOTH FORM FINISH."
- SPLICING OF REINFORCEMENT IS PERMITTED ONLY AT LOCATIONS SHOWN IN THE CONTRACT DRAWINGS OR AS ACCEPTED BY THE ENGINEER. UNLESS OTHERWISE SHOWN OR NOTED REINFORCING STEEL SHALL BE SPLICED TO DEVELOP ITS FULL TENSILE CAPACITY (CLASS A) IN ACCORDANCE WITH ACL 318
- DETAILING OF REINFORCING STEEL SHALL CONFORM TO "ACLIMANUAL OF STANDARD
- ALL SLAB CONSTRUCTION SHALL BE CAST MONOLITHICALLY WITHOUT HORIZONTAL CONSTRUCTION JOINTS, UNLESS SHOWN IN THE CONTRACT DRAWINGS
- LOCATION OF ALL CONSTRUCTION JOINTS ARE SUBJECT TO THE REQUIREMENTS OF THE CONTRACT DOCUMENTS, CONFORMANCE WITH ACI 318, AND ACCEPTANCE OF THE ENGINEER. DRAWINGS SHOWING LOCATION OF DETAILS OF THE PROPOSED CONSTRUCTION JOINTS SHALL BE SUBMITTED WITH REINFORCING STEEL PLACEMENT
- SPLICES OF WWF, AT ALL SPLICED EDGES, SHALL BE SUCH THAT THE OVERLAP MEASURED BETWEEN OUTERMOST CROSS WIRES OF EACH FABRIC SHEET IS NOT LESS THAN THE SPACING OF THE CROSS WIRE PLUS 2 INCHES, NOR LESS THAN 6"
- BAR SUPPORTS SHALL BE ALL-GALVANIZED METAL WITH PLASTIC TIPS
- ALL REINFORCEMENT SHALL BE SECURELY TIED IN PLACE TO PREVENT DISPLACEMENT BY CONSTRUCTION TRAFFIC OR CONCRETE. TIE WIRE SHALL BE OF SUFFICIENT STRENGTH FOR INTENDED PURPOSE, BUT NOT LESS THAN NO. 18 GAUGE
- SLAB ON GROUND: COMPACT STRUCTURAL FILL TO 95% DENSITY AND THEN PLACE 6" GRAVEL BENEATH SLAB.

## **ELECTRICAL NOTES:**

- ELECTRICAL DESIGN SHALL BE PERFORMED BY ELECTRICAL CONTRACTOR. STRUCTURAL DESIGN SHALL BE PERFORMED BY GENERAL CONTRACTOR. ELECTRICAL CONTRACTOR SHALL ENSURE THAT ALL WORK COMPLIES WITH ALL APPLICABLE LOCAL AND STATE CODES AND NATIONAL ELECTRICAL CODE.
- ALL SUGGESTED ELECTRICAL ELEMENTS (SUCH AS BREAKER SIZES, WIRE SIZES, CONDUITS SIZES ARE FOR ZONING PURPOSES ONLY. IT IS THE RESPONSIBILITY TO OF THE ELECTRICAL CONTRACTOR TO CONFIRM COMPLIANCE WITH LOCAL ELECTRICAL CODES AND PASS ALL APPLICABLE AND NECESSARY INSPECTIONS. IN SOME EVENTS, IT MAY BE NECESSARY TO PERFORM AN ELECTRICAL LOAD STUDY TO VERIFY THE CAPACITY OF THE EXISTING SERVICE. THIS IS NOT THE RESPONSIBILITY OF CONCORDIA IT IS THE RESPONSIBILITY OF THE ELECTRICAL CONTRACTOR
- CONTRACTOR SHALL FIELD LOCATE ALL BELOW GRADE GROUND LINES AND UTILITY LINES PRIOR TO CONSTRUCTION. CONTRACTOR IS RESPONSIBLE FOR RELOCATION OF ALL UTILITIES AND GROUND LINES THAT MAY BECOME DISTURBED OR CONFLICTING IN THE COURSE OF CONSTRUCTION

ALL DISCREPANCIES FROM WHAT IS SHOWN ON THESE CONSTRUCTION DRAWINGS SHALL BE COMMUNICATED TO ATC ENGINEERING IMMEDIATELY FOR CORRECTION OR RE-DESIGN FAILURE TO COMMUNICATE DIRECTLY WITH ATC ENGINEERING OR ANY CHANGES FROM THE DESIGN CONDUCTED WITHOUT PRIOR APPROVAL FROM ATC ENGINEERING SHALL BE THE SOLE RESPONSIBILITY OF THE GENERAL CONTRACTOR.



DESCRIPTION BY DATE **PRELIM** RW 01/25/21 REVISED PER COMMENTS JPB 03/12/21 FINAL TMM 09/01/21


> ATC SITE NUMBER: 373155

ATC SITE NAME: PARLIN - SAYREVILLE

AT&T MOBILITY SITE NAME:

PARLIN - NYCWNJ5836

SITE ADDRESS: 775 WASHINGTON ROAD PARLIN. NJ 08859-0000

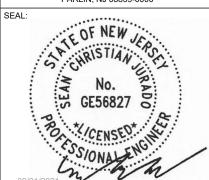



DATE DRAWN: 01/20/21 13325346 G2 ATC JOB NO: CUSTOMER ID: NWL05836 CUSTOMER #: 14652316

**GENERAL NOTES** 

SHEET NUMBER

G-002

## LEGEND

EXISTING PROPERTY LINE
EXISTING ADJACENT PROPERTY LINE EXISTING LEASE AREA EXISTING EASEMENT EXISTING WOOD FENCE EXISTING WIRE FENCE

EXISTING METAL FENCE

EXISTING CHAINLINK FENCE EXISTING ROAD (DIRT) EXISTING ROAD (STONE)



## EXISTING STRUCTURES WITHIN 200' OF PROPERTY LINE

EXISTING ROAD (PAVED)

NORTH	±136'
EAST	±9'
SOUTH	±106'
WEST	±34'

EXISTING STRUCTURES OUTWARD ±500' C				
SCHOOL	> 500'			
PARK	> 500'			
DAY CARE CENTER	> 500'			
CELL TOWER	> 500'			
NEAREST RESIDENTIAL AREA	±59'			
NEAREST RESIDENTIAL STRUCTURE	±136'			
	PROPERTY I SCHOOL PARK DAY CARE CENTER CELL TOWER NEAREST RESIDENTIAL AREA NEAREST RESIDENTIAL			


## TRACT DESCRIPTION:


- NORTHERLY AND ALONG THE AFORESAID DIVIDING LINE AND BINDING THEREON 500 FEET TO A POINT; THENCE
- 2. EASTERLY AND PARALLEL WITH WASHINGTON ROAD, 200 FEET TO A
- 3. SOUTHERLY AND PARALLEL WITH THE FIRST COURSE, 500 FEET TO A POINT IN THE NORTHERLY LING OF WASHINGTON ROAD; THENCE
- WESTERLY AND ALONG THE NORTHERLY LING OF SAID WASHINGTON ROAD AND BINDING THEREON 200 FEET TO THE POINT OR PLACE OF

(FOR MORE DETAILED ZONING INFORMATION SEE ZONING TABLE ON PAGE R-608)

ZONE 4 D. NEIGURORUGOD RUGINEGO					
ZONE 1-B: NEIGHBORHOOD BUSINESS					
ITEM	REQUIRED	EXISTING	PROPOSED		
MIN AREA SQ. FT	10,000	99,734	NO CHANGE		
MIN LOT WIDTH	100'	200'	NO CHANGE		
MIN LOT DEPTH	100'	500'	NO CHANGE		
MIN FRONT YARD SETBACK	20'	35'-2"	NO CHANGE		
MIN SIDE YARD SETBACK ONE	10'	10'-10"'	NO CHANGE		
MIN SIDE YARD SETBACK BOTH	20'	31'-1"	NO CHANGE		
MIN REAR YARD SETBACK	20'	23'-1"	NO CHANGE		
MAX BUILDING HEIGHT	35'	(E) 125'	NO CHANGE		
MAX LOT COVERAGE (BUILDING)	25%	8.6%	NO CHANGE		
MAX LOT COVERAGE (BUILDING & PAVEMENT	85%	46.61%	46.91%		

ADDITIONAL TELECOMMUNICATIONS REQUIREMENTS (ORDINANCE 26-87)				
ITEM	REQUIRED	EXISTING	PROPOSED	
MAX TOWER HEIGHT	150'	125'	NO CHANGE	
FRONT YARD SETBACK (75% TW. HT.)	93.75'	447'	NO CHANGE	
SIDE YARD SETBACK - EAST (75% TWR. HT.)	93.75'	147'-2"	NO CHANGE	
SIDE YARD SETBACK - WEST (75% TWR. HT.)	93.75'	(E) 24'-6"	NO CHANGE	
REAR YARD SETBACK (75% OF TWR. HT.)	93.75'	(E) 28'-1"	NO CHANGE	

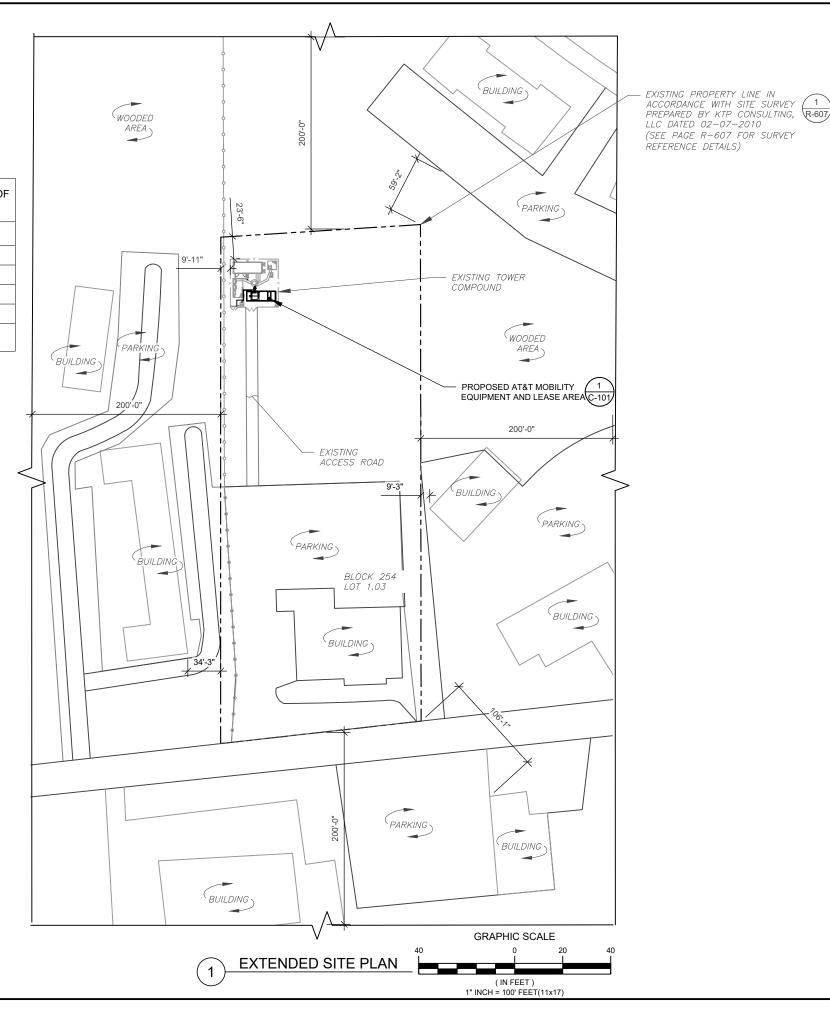

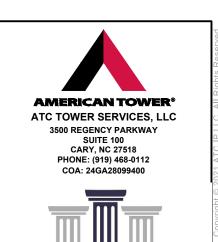

DESCRIPTION RW 01/25/21 REVISED PER COMMENTS JPB 03/12/21 TMM 09/01/21

> ATC SITE NUMBER: 373155

ATC SITE NAME: PARLIN - SAYREVILLE

AT&T MOBILITY SITE NAME:

PARLIN - NYCWNJ5836

SITE ADDRESS: 775 WASHINGTON ROAD PARLIN, NJ 08859-0000





DATE DRAWN:	01/20/21
ATC JOB NO:	13325346_G2
CUSTOMER ID:	NWL05836
CUSTOMER #:	14652316


**EXTENDED SITE PLAN** 

SHEET NUMBER:

REVISION:

C-001

В

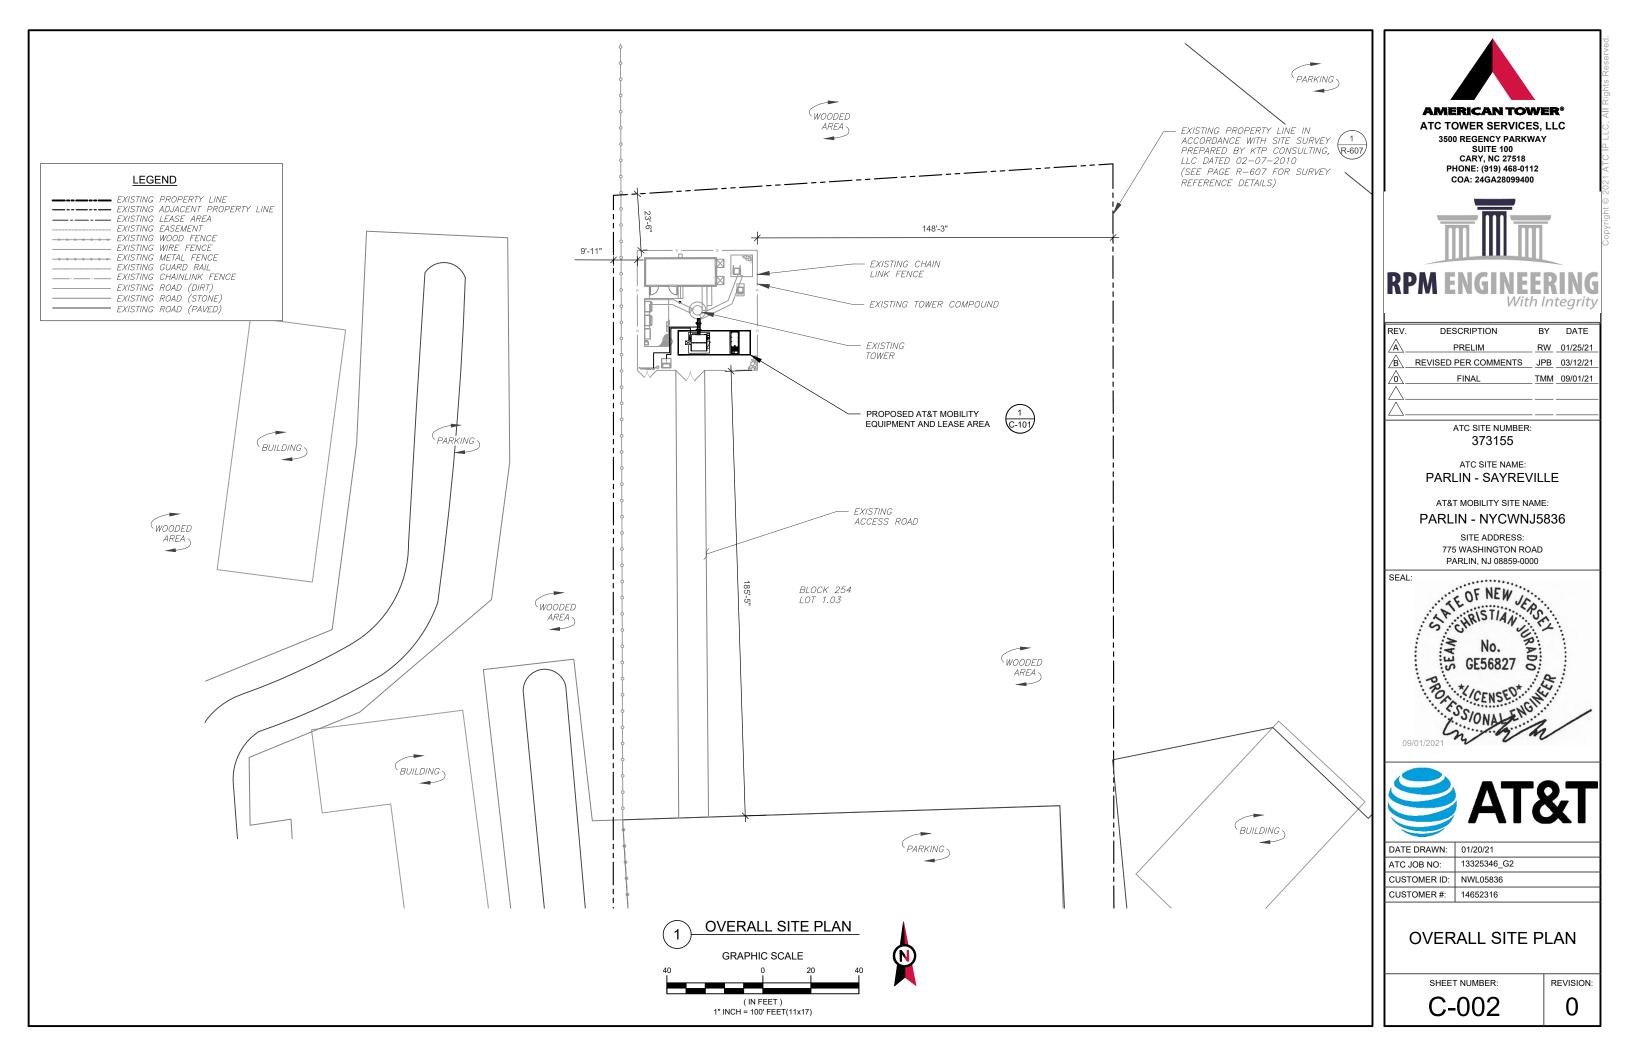


## SITE PLAN NOTES:

MOUNTED TO TOWER USING STAINLESS STEEL

BANDING. ADEQUATELY SECURE CABLES USING EITHER APPROPRIATELY SIZED STAINLESS STEEL

SNAP-INS OR MOUNTING HARDWARE AND BRACKETS AS SPECIFIED BY CABLE MANUFACTURER.

- 1. THIS SITE PLAN REPRESENTS THE BEST PRESENT KNOWLEDGE AVAILABLE TO THE ENGINEER AT THE TIME OF THIS DESIGN. THE CONTRACTOR SHALL VISIT THE SITE PRIOR TO CONSTRUCTION AND VERIFY ALL EXISTING CONDITIONS RELATED TO THE SCOPE OF WORK FOR THIS PROJECT.
- ICE BRIDGE, CABLE LADDER, COAX PORT, AND COAX CABLE ARE SHOWN FOR REFERENCE ONLY. CONTRACTOR SHALL CONFIRM THE EXACT LOCATION OF ALL PROPOSED AND EXISTING EQUIPMENT AND STRUCTURES DEPICTED ON THIS PLAN. BEFORE UTILIZING EXISTING CABLE SUPPORTS, COAX PORTS, INSTALLING NEW PORTS OR ANY OTHER EQUIPMENT, CONTRACTOR SHALL VERIFY ALL ASPECTS OF THE COMPONENTS MEET THE ATC SPECIFICATIONS.
- 3. IT IS THE RESPONSIBILITY OF THE CONTRACTOR TO COORDINATE WITH THE AT&T MOBILITY REPRESENTATIVE AND LOCAL UTILITY COMPANY FOR THE INSTALLATION OF CONDUITS, CONDUCTORS, BREAKERS, DISCONNECTS, OR ANY OTHER EQUIPMENT REQUIRED FOR ELECTRICAL SERVICE. ALL ELECTRICAL WORK SHALL BE

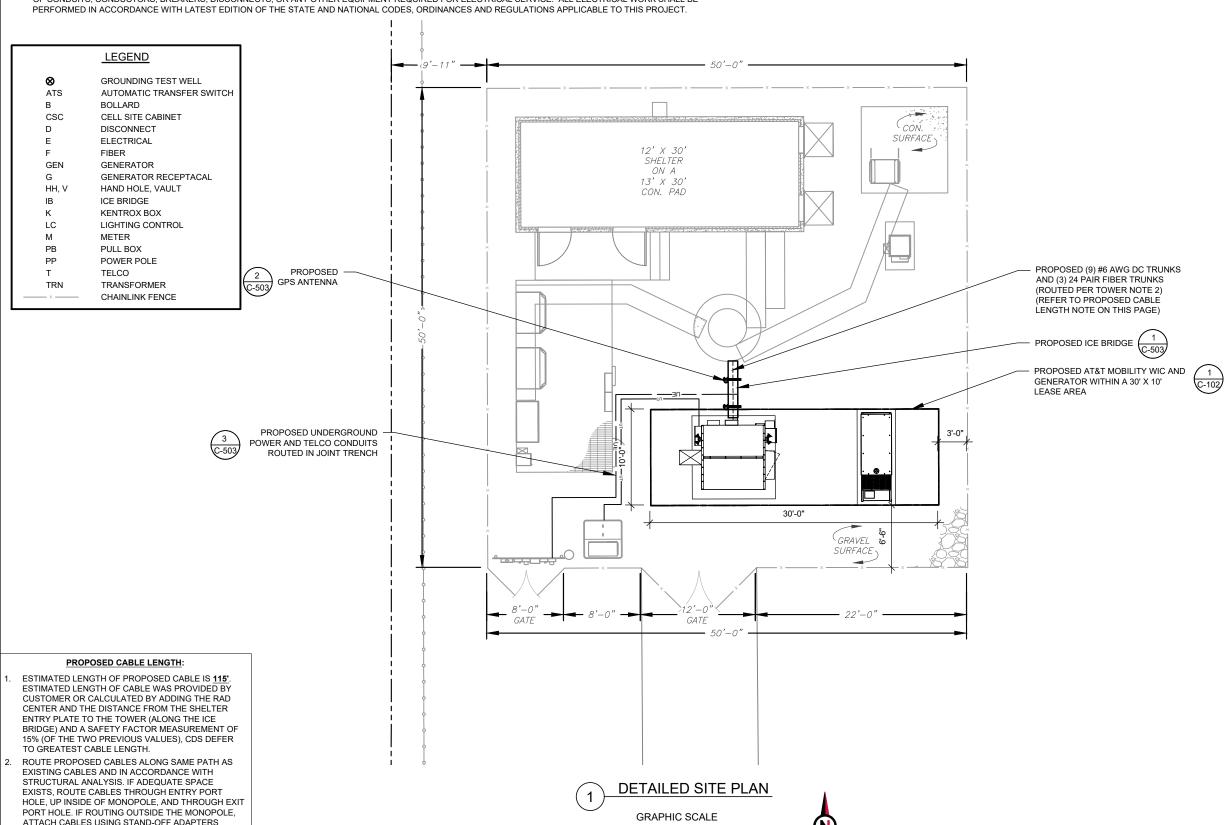

1 UNIT = 10 FEET



3500 REGENCY PARKWAY SUITE 100 CARY, NC 27518 PHONE: (919) 468-0112 COA: 24GA28099400



REV.	DESCRIPTION	BY	DATE
$\mathbb{A}_{-}$	PRELIM	RW	01/25/21
B\_	REVISED PER COMMENTS	JPB	03/12/21
$\overline{\Diamond}$	FINAL	TMM	09/01/21
$\overline{\wedge}$			
$\overline{\wedge}$			

ATC SITE NUMBER: 373155

ATC SITE NAME:
PARLIN - SAYREVILLE

AT&T MOBILITY SITE NAME:

PARLIN - NYCWNJ5836

SITE ADDRESS: 775 WASHINGTON ROAD PARLIN, NJ 08859-0000





DATE DRAWN:	01/20/21
ATC JOB NO:	13325346_G2
CUSTOMER ID:	NWL05836
CUSTOMER #:	14652316

**DETAILED SITE PLAN** 

SHEET NUMBER:

REVISION:


C-101

В

## **GROUND SOW**

- INSTALL VERTIV WIC W/ VERTIV 7100 PP, (8) RECTIFIERS, & (0) CONVERTERS

- INSTALL VERTIV WIG W/ VERTIV /
   INSTALL (1) FSM4 AMIA IN FIF
   INSTALL (1) 5G AMIA IN FIF
   INSTALL (1) DC12RM IN FIF
   INSTALL (2) FIBER TRAYS IN FIF
   INSTALL (2) FMBS AT ICEBRIDGE

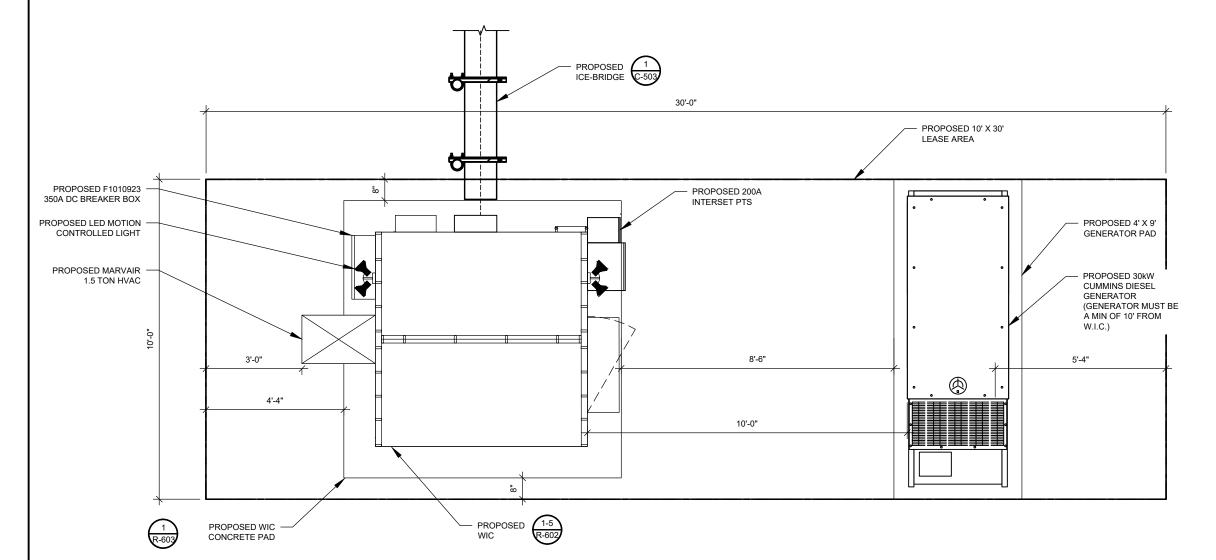

**DETAILED EQUIPMENT LAYOUT** 





REV.	DESCRIPTION	BY	DATE
A	PRELIM	RW	01/25/21
B\_	REVISED PER COMMENTS	JPB	03/12/21
<u></u>	FINAL	TMM	09/01/21
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$\triangle$			

ATC SITE NUMBER: 373155

ATC SITE NAME: PARLIN - SAYREVILLE

AT&T MOBILITY SITE NAME:

PARLIN - NYCWNJ5836

SITE ADDRESS: 775 WASHINGTON ROAD PARLIN, NJ 08859-0000






DATE DRAWN:	01/20/21
ATC JOB NO:	13325346_G2
CUSTOMER ID:	NWL05836
CUSTOMER #:	14652316
	ATC JOB NO: CUSTOMER ID:

**DETAILED EQUIPMENT LAYOUT** 

SHEET NUMBER:

C-102

В

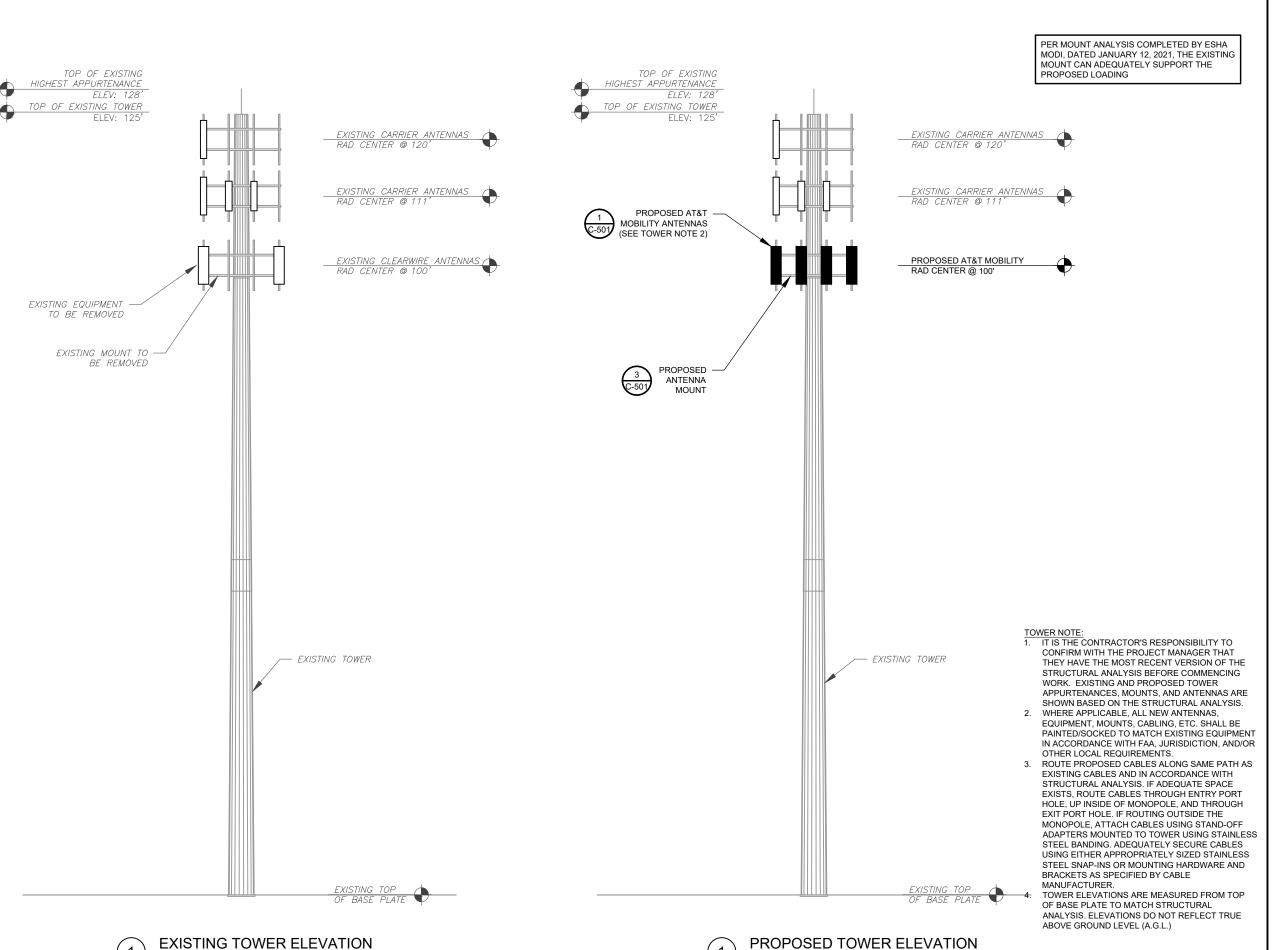

SCALE: N.T.S.



			,
REV.	DESCRIPTION	BY	DATE
ΛΕV.	DESCRIPTION	ы	DATE
<u> </u>	PRELIM	RW	01/25/21
B_	REVISED PER COMMENTS	JPB	03/12/21
<u></u>	FINAL	TMM	09/01/21
$\triangle_{-}$			

ATC SITE NUMBER: 373155

ATC SITE NAME: PARLIN - SAYREVILLE

AT&T MOBILITY SITE NAME:

PARLIN - NYCWNJ5836

SITE ADDRESS: 775 WASHINGTON ROAD PARLIN, NJ 08859-0000





DATE DRAWN:	01/20/21
ATC JOB NO:	13325346_G2
CUSTOMER ID:	NWL05836
CUSTOMER #:	14652316


## **DETAILED SITE PLAN & TOWER ELEVATION**

SHEET NUMBER:

SCALE: N.T.S.

C-201

В

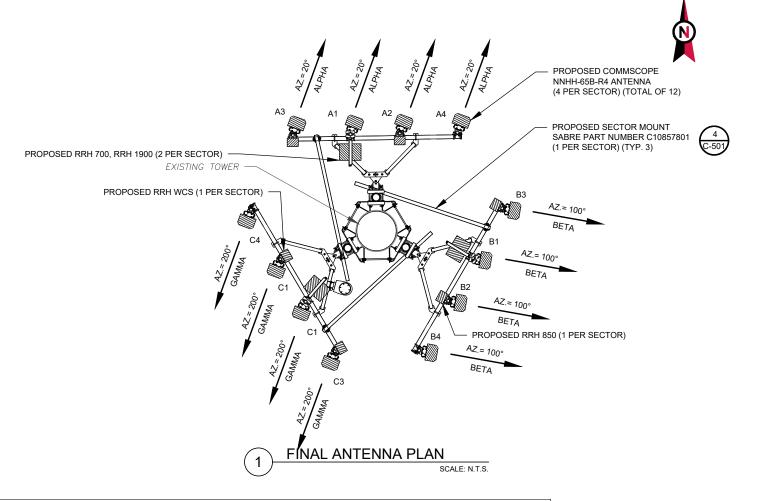

					FINAL ANTENNA SCHE	DULE			
LO	CATION			AN	TENNA SUMMARY			NON ANTENNA SUMMA	RY
SECTOR	RAD	AZ	POS	ANTENNA	BAND	MECH/ELEC D-TILT	STATUS	ADDITIONAL TOWER MOUNTED EQUIPMENT	STATUS
			A3	NNHH-65B-R4	RRH-WCS	0	ADD	AIRSCALE RRH 4T4R B30 100W AHNA	ADD
ALPHA	100'	20°	A1	NNHH-65B-R4	RRH-700, RRH-1900	0	ADD	AIRSCALE TRI RRH 4T4R B12/14/29 370W AHLBBA, AIRSCALE DUAL RRH 4T4R B25 / 66 320W AHFIB	ADD
ALITIA	100	20	A2	NNHH-65B-R4	RRH-850	0	ADD	AIRSCALE RRH 4T4R B5 160W AHCA	ADD
			A4	NNHH-65B-R4	-	0	ADD		-
			В3	NNHH-65B-R4	RRH-WCS	0	ADD	AIRSCALE RRH 4T4R B30 100W AHNA	ADD
ВЕТА	100'	100°	B1	NNHH-65B-R4	RRH-700, RRH-1900	0	ADD	AIRSCALE TRI RRH 4T4R B12/14/29 370W AHLBBA, AIRSCALE DUAL RRH 4T4R B25 / 66 320W AHFIB	ADD
			B2	NNHH-65B-R4	RRH-850	0	ADD	AIRSCALE RRH 4T4R B5 160W AHCA	ADD
			B4	NNHH-65B-R4	-	0	ADD	-	-
			СЗ	NNHH-65B-R4	RRH-WCS	0	ADD	AIRSCALE RRH 4T4R B30 100W AHNA	ADD
GAMMA	100'	200°	C1	NNHH-65B-R4	RRH-700, RRH-1900	0	ADD	AIRSCALE TRI RRH 4T4R B12/14/29 370W AHLBBA, AIRSCALE DUAL RRH 4T4R B25 / 66 320W AHFIB	ADD
			C2	NNHH-65B-R4	RRH-850	0	ADD	AIRSCALE RRH 4T4R B5 160W AHCA	ADD
			C4	NNHH-65B-R4	-	0	ADD	-	-

1. CONFIRM WITH AT&T MOBILITY REP FOR APPLICABLE UPDATES/REVISIONS AND MOST RECENT RFDS FOR NSN CONFIGURATION (CONFIG).

2. CONFIRM SPACING OF PROPOSED EQUIP DOES NOT CAUSE TOWER CONFLICTS NOR IMPEDE TOWER CLIMBING PEGS.

GC TO CAP ALL UNUSED PORTS.

CABLE LENGTHS FOR JUMPERS FIBER DISTRIBUTION/OVP TO RRU: 15' COMBINER TO ANTENNA: 10'

PROPOSED FIBER DISTRIBUTION/OVP BOX PROPOSED CABLING SUMMARY FIBER/DC MODEL NUMBER STATUS STATUS COAX TRUNKS (3) FIBER 24-PAIR ADD ADD 6 AWG 6 ADD (9) DC TRUNKS

ANTENNA SCHEDULE

(5) 2" INNERDUCTS [(3) WITH (1) FIBER & (2) DC TRUNKS, (1) WITH (2) DC TRUNKS, AND (1) WITH (1) DC TRUNK]



COA: 24GA28099400



REV.	DESCRIPTION	BY	DATE
$\triangle_{-}$	PRELIM	RW	01/25/21
B_	REVISED PER COMMENTS	JPB	03/12/21
<u></u>	FINAL	TMM	09/01/21
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ATC SITE NUMBER: 373155

ATC SITE NAME: PARLIN - SAYREVILLE

AT&T MOBILITY SITE NAME:

PARLIN - NYCWNJ5836

SITE ADDRESS: 775 WASHINGTON ROAD PARLIN, NJ 08859-0000






	DATE DRAWN:	01/20/21
	ATC JOB NO:	13325346_G2
	CUSTOMER ID:	NWL05836
	CUSTOMER #:	14652316


ANTENNA INFORMATION & SCHEDULE

SHEET NUMBER:

REVISION: C-401

В

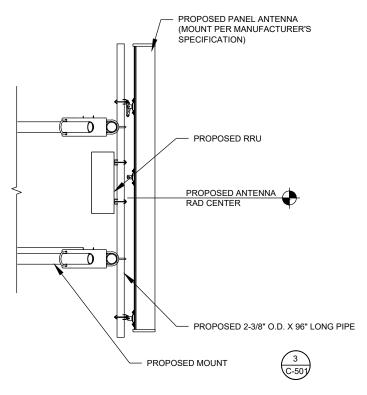


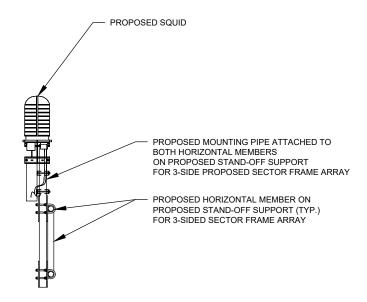

PROPOSED ANTENNA MOUNTING DETAIL (ELEVATION)

SCALE: NOT TO SCALE


PROPOSED OVP MOUNTING
SCALE: NOT TO SCALE

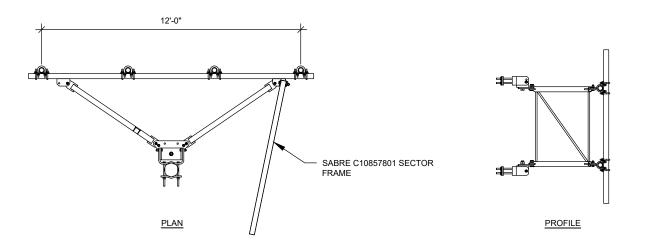

3 SECTOR FRAME DETAIL

SCALE: N.T.S.



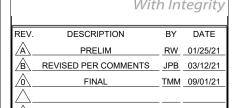

ATC SITE NUMBER: 373155

ATC SITE NAME:
PARLIN - SAYREVILLE

AT&T MOBILITY SITE NAME:

PARLIN - NYCWNJ5836

SITE ADDRESS: 775 WASHINGTON ROAD PARLIN, NJ 08859-0000






	DATE DRAWN:	01/20/21
	ATC JOB NO:	13325346_G2
	CUSTOMER ID:	NWL05836
	CUSTOMER #:	14652316

CONSTRUCTION DETAILS

SHEET NUMBER:

C-501

В

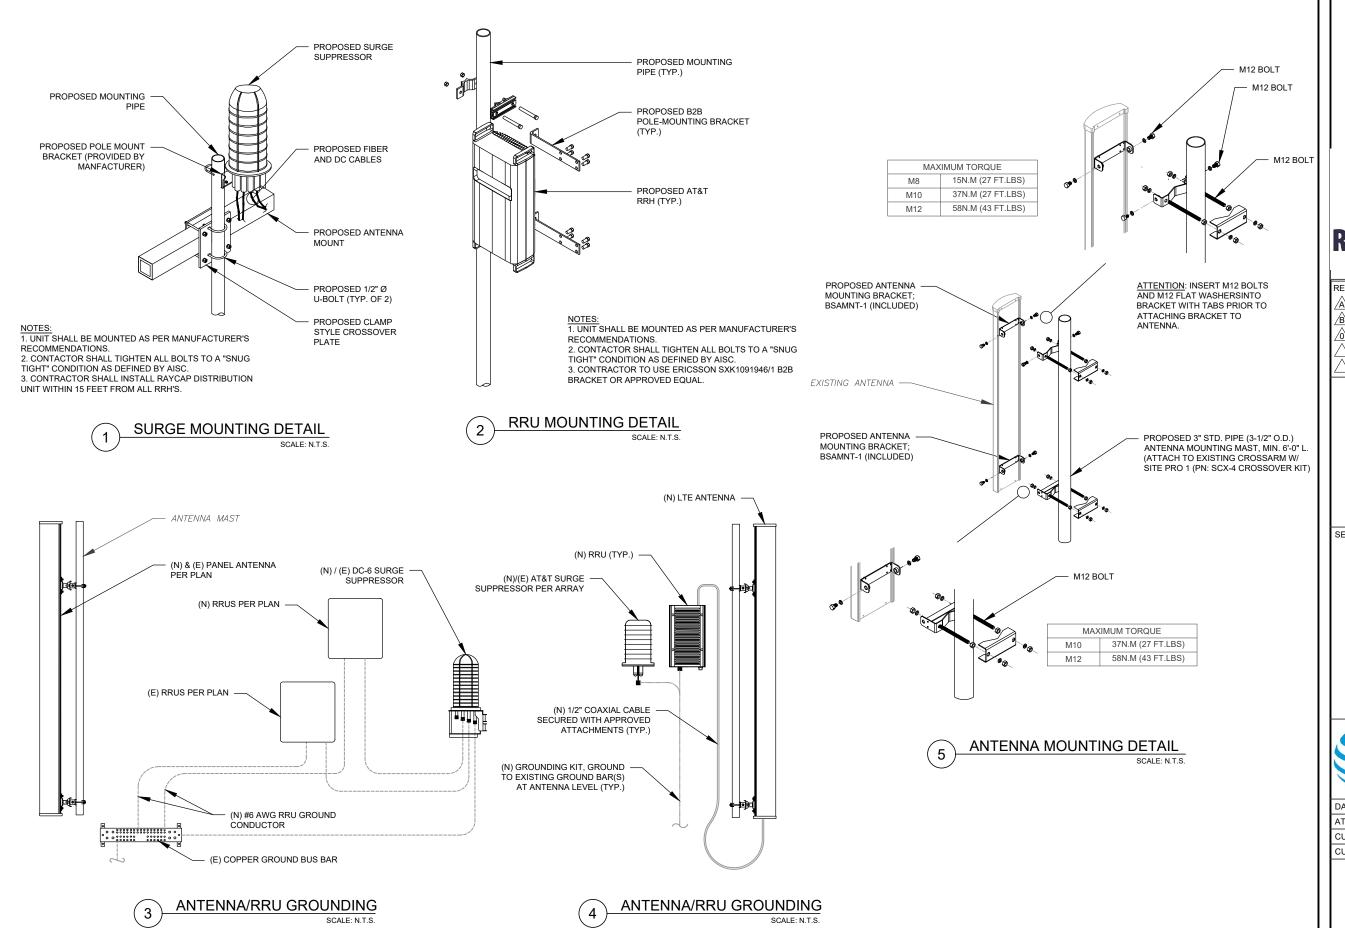



REV. DESCRIPTION BY DATE

A PRELIM RW 01/27/21

B REVISED PER COMMENTS JPB 03/12/21

O FINAL TMM 09/01/21


ATC SITE NUMBER: 373155

ATC SITE NAME:
PARLIN - SAYREVILLE

AT&T MOBILITY SITE NAME:

PARLIN - NYCWNJ5836

SITE ADDRESS: 775 WASHINGTON ROAD PARLIN, NJ 08859-0000

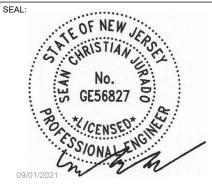



DATE DRAWN:	01/20/21
ATC JOB NO:	13325346_G2
CUSTOMER ID:	NWL05836
CUSTOMER #:	14652316

# CONSTRUCTION DETAILS

SHEET NUMBER:


REVISION:

C-502

В

## CONSTRUCTION NOTE:


1. INSTALL ICE BRIDGE TO ALLOW 7 FEET CLEARANCE ABOVE GRADE TO LOWEST APPURTENANCE.

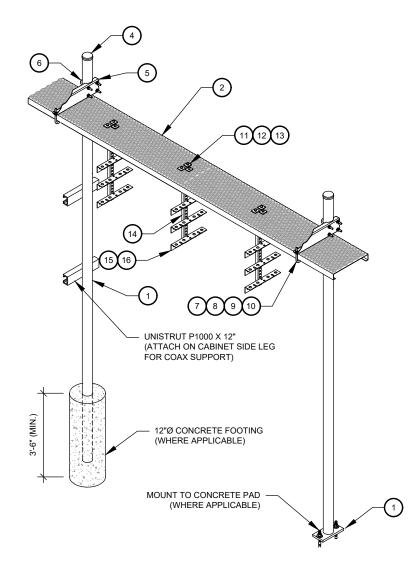

WB-	K210-B WAVEGU	JIDE BRIDGE KIT - BILL OF MATERIA	LS (INCL	UDED WITH KI	T UNLESS NOTED OTHERWISE)
ITEM	PART NUMBER	DESCRIPTION	ITEM	PART NUMBER	DESCRIPTION
1	MF126.01 MF-130	10'-4" COLUMN & BASE SHOE* 13'-4" PIPE COLUMN	9	GWL-04	1/2" GALV LOCK WASHER
2	WB-CY210	SAFETY GRATING 24" X 10'	10	GN-04	1/2" GALV HEX NUT
3	WBK110BHK	HARDWARE KIT (ITEMS 4-16)	11	GB-03205	3/8" X 2" GALV BOLT KIT
4	PC-034	PIPE CAP 3-1/2"	12	MT-387	SQUARE WASHER, 1-1/2" X 1-1/2" W/ 7/16" HOLE
5	WBLB243.08	24" WAVEGUIDE BRIDGE SUPPORT BRACKET	13	GWF-03	3/8" GALV FLAT WASHER
6	GUB-4356	1/2" X 3-5/8" X 6" GALV U-BOLT	14	WBT243.01	VERTICAL TRAPEZE SECTION
7	WB-JB-6	1/2" J-BOLT	15	GB-03105	3/8" X 1" GALV BOLT KIT
8	GWF-04	1/2" GALV FLAT WASHER	16	WBT243.02	HORIZONTAL TRAPEZE SECTION


CONTRACTOR SHALL USE PARTS MANUFACTURED BY COMMSCOPE OR APPROVED EQUIVALENT. \*BASE SHOE NOT INCLUDED IN WB-K210-B KIT, ORDER COLUMN SEPARATELY OR KIT WB-K210-S.

> WAVEGUIDE BRIDGE KIT SCALE: NOT TO SCALE

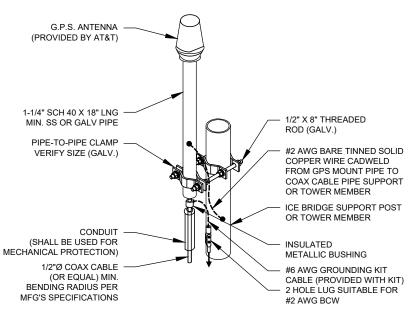

- GPS SHALL BE PLACED WITH CLEAR SIGHT LINE TO THE SOUTHERN SKY.
- CONTRACTOR TO SUPPLY COAX FOR GPS UNIT.




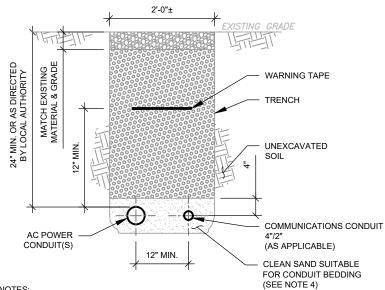

## TRENCH NOTES:

- IF FREE OF ORGANIC OR OTHER DELETERIOUS MATERIAL, EXCAVATED MATERIAL MAY BE USED FOR BACKFILL. IF NOT, PROVIDE CLEAN, COMPACTIBLE MATERIAL.
  COMPACT IN 8" LIFTS. REMOVE ANY LARGE ROCKS PRIOR TO BACKFILLING. CONTRACTOR
- TO VERIFY LOCATION OF EXISTING U/G UTILITIES PRIOR TO DIGGING.
- IF CURRENT AS-BUILT DRAWINGS ARE NOT AVAILABLE CONTRACTOR SHALL HAND DIG
- USE COMMUNICATIONS ONLY TRENCH FOR COMMUNICATIONS CONDUIT UNLESS TRAVELING UNDER PATH OF VEHICLE TRAVEL, THEN CONDUIT MUST BE 24" MIN. BELOW
- CONFIRM SPACING AND DEPTH WITH NEC OR LOCAL CODE REQUIREMENTS

POWER/TELCO CONDUIT TRENCH DETAILS

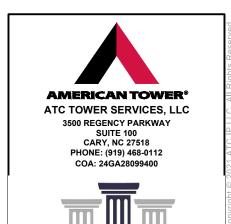

	Wit	h In	tegrity
REV.	DESCRIPTION	BY	DATE
$\mathbb{A}_{-}$	PRELIM	RW	01/25/21
<u>B</u> _	REVISED PER COMMENTS	JPB	03/12/21
<u> </u>	FINAL	TMM	09/01/21
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ATC SITE NUMBER: 373155

ATC SITE NAME: PARLIN - SAYREVILLE

AT&T MOBILITY SITE NAME:

PARLIN - NYCWNJ5836

SITE ADDRESS: 775 WASHINGTON ROAD PARLIN. NJ 08859-0000







	DATE DRAWN:	01/20/21
	ATC JOB NO:	13325346_G2
	CUSTOMER ID:	NWL05836
	CUSTOMER #:	14652316

CONSTRUCTION **DETAILS** 


SHEET NUMBER:

C-503

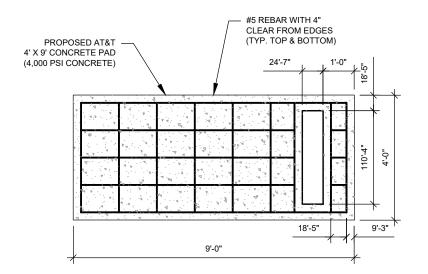

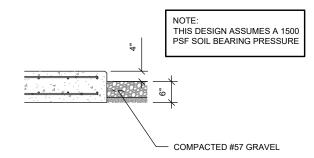


# CONCRETE GENERATOR PAD DESIGN

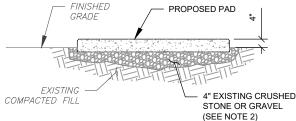


## PAD NOTES:


- 1. SUBGRADE AND FILL SHALL CONSIST OF CLEAN SOIL. DELETRIOUS MATERIAL AND ORGANICS SHALL BE REMOVED.
- 2. MECHANICALLY COMPACT FOOTPRINT OF PAD PLUS 2' PERIMETER.
- USE GALVANIZED HILTI EXPANSION ANCHORS OR, APPROVED EQUAL, FOR
- 4. FOR SIZE AND LOCATION OF ANCHORS AND OTHER REQUIREMENT, SEE EQUIPMENT VENDOR DRAWINGS.

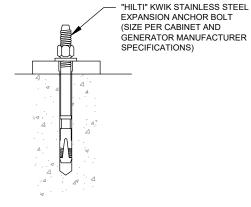

**EXPANSION ANCHOR DETAIL** 

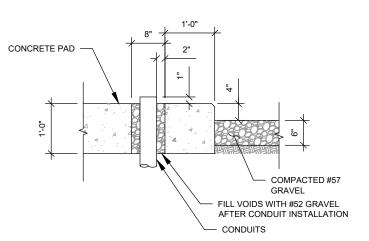


GENERATOR CONDUIT STUB UP DETAIL

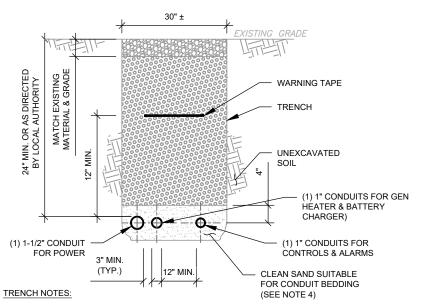

- IF FREE OF ORGANIC OR OTHER DELETERIOUS MATERIAL, EXCAVATED MATERIAL MAY
- BE USED FOR BACKFILL. IF NOT, PROVIDE CLEAN, COMPACTIBLE MATERIAL. COMPACT IN 8" LIFTS. REMOVE ANY LARGE ROCKS PRIOR TO BACKFILLING.
- CONTRACTOR TO VERIFY LOCATION OF EXISTING U/G UTILITIES PRIOR TO DIGGING.
- IF CURRENT AS-BUILT DRAWINGS ARE NOT AVAILABLE CONTRACTOR SHALL HAND DIG
- USE COMMUNICATIONS ONLY TRENCH FOR COMMUNICATIONS CONDUIT UNLESS TRAVELING UNDER PATH OF VEHICLE TRAVEL, THEN CONDUIT MUST BE 24" MIN.
- CONFIRM SPACING AND DEPTH WITH NEC OR LOCAL CODE REQUIREMENTS



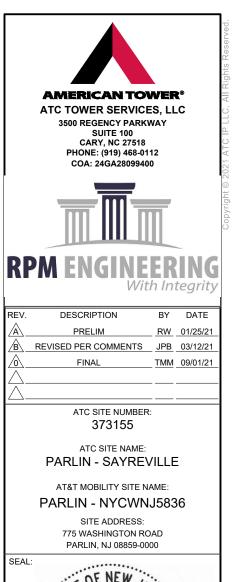





## CONSTRUCTION **DETAILS**

SHEET NUMBER:

C-504





## Diesel generator set

25 kW - 40 kW **EPA** emissions stationary Standby



Cummins® generator sets are fully integrated power generation systems providing optimum performance, reliability and versatility for stationary Standby applications.

Alternator - Several alternator sizes offer selectable motor starting capability with low reactance 2/3 pitch windings, low waveform distortion with non-linear loads and fault clearing short-circuit capability.

Control system - The PowerCommand® 1.1 electronic control is standard equipment and provides total generator set system integration including automatic remote starting/stopping, precise frequency and voltage regulation, alarm and status message display, output metering, auto-shutdown at fault detection and NFPA 110.

Level 1 compliance. — The PowerCommand® 1.1 electronic and status message display, output metering, auto-shutdown at fault detection and NFPA 110.

Level 1 compliance. — Warrarty and service - Backed by a



Cooling system - Standard cooling package provides reliable running at up to 50 ℃ (122 ℉) ambient temperature.

Enclosures - The aesthetically appealing Enclosures - The aesthetically appealing enclosure incorporates special designs this that deliver one of the queletest generators of its that deliver one of the queletest generators of its that Aluminum material plus durable powder coat paint provides the best anti-corrosion performance. The generator set enclosure has been evaluated to withstand 180 Minstand 180 Min intelligent design has removable panels and service doors to provide easy access for service and maintenance.

Fuel tanks - Two dual wall sub-base fuel tank

Warranty and service - Backed by a comprehensive warranty and worldwide distributor network.

		y rating Hz	Prime rating 60 Hz		Data sheets 60 Hz	
Model	kW	kVA	kW	kVA		
C25 D6	25	31.3	22.7	28.4	NAD-5860	
C30 D6	30	37.5	27	33.8	NAD-5861	
C35 D6	35	43.8	32	40	NAD-5862	
C40 D6	40	50	36	45	NAD-5863	

Our energy working for you."

## Generator set specifications

Governor regulation class	ISO8528 Part 1 Class G2
Voltage regulation, no load to full load	± 1.0%
Random voltage variation	± 0.5% - 3 Phase only
Frequency regulation	Isochronous
Random frequency variation	± 0.5%
Radio frequency emissions compliance	FCC code Title 47 Part 15 Class B

ngine specifications	
re	95.0 mm (3.74 in.)
oke	115.1 mm (4.53 in.)
placement	3.3 litres (199 in <sup>3</sup> )
nfiguration	Cast iron, in-line, 4 cylinder
ttery capacity	550 amps at ambient temperature of 0 °F to 32 °F (-18 °C to 0 °C)
ttery charging alternator	40 amps
arting voltage	12 volt, negative ground
el system	Indirect injection, number 2 diesel fuel, fuel filter, electric fuel shut off
el filter	Single element, 10 micron filtration, spin-on fuel filter with water separator
cleaner type	Dry replaceable element
be oil filter type(s)	Spin-on, full flow
andard cooling system	50 °C (122 °F) ambient cooling system

Alternator specifications	
Design	Brushless, 4 pole, drip proof, revolving field
Stator	2/3 pitch
Rotor	Direct coupled, flexible disc
Insulation system	Class H per NEMA MG1-1.65
Standard temperature rise	120 °C (248 °F) Standby
Exciter type	Torque match (shunt) with PMG/EBS as option
Alternator cooling	Direct drive centrifugal blower
AC waveform Total Harmonic Distortion (THDV)	< 5% no load to full linear load, < 3% for any single harmonic
Telephone Influence Factor (TIF)	< 50 per NEMA MG1-22.43
Telephone Harmonic Factor (THF)	0.03

Single phase	3 phase			
• 120/240	• 120/208	<ul> <li>120/240 delta</li> </ul>	• 277/480	• 347/600

## Generator set options

- Hegional fuel tanks
   Engine
   Engine air cleaner normal or heavy duty
   Shut down low oil pressure
   Extension oil drain
- Alternator 120 °C (248 °F) temperature rise

Our energy working for you."

- alternator

  105 °C (221 °F) temperature rise alternator
- Excitation Boost System (EBS) or PMG
   Alternator heater, 120 V Aluminum enclosure sound level or level 2, with muffler installed, sandstone or green color
   Open set

# Control AC output analog meters (bargraph) Sipo switch — emergency Auxiliary output relays (2) Auxiliary configurable signal inputs (8) and relay outputs (8) Electrical Single circuit breakers Dual circuit breakers 100% rated circuit breakers 100% rated circuit breakers Foolows reserved Foolow

- Cooling system

  Shuldown low coolant level
  Warning low coolant level
  Extension coolant drain
  Cool weather option for operating at 41 °C (40 °F)
  Exhaust system
  Exhaust connector NPT
  Open set with muffler mounted
  Generator set application
  Battery rack, larger battery
  Radiator outlet duct adapter

## Our energy working for you."

Generator set options (continued)

- Warranty

  Standby, 5 year, 2500 hour, parts and labor
  Standby, 3 year, 1500 hour, parts
  Labor and travel
  Labor and Labor and travel
  Labor and travel
  Labor and travel
  Labor and travel
  Labor and Labor and travel
  Labor and Labor and travel
  Labor and Labo
- Extreme cold weather list

  Battery rack, larger battery

  Battery rack, larger battery

  Battery hadra rist

  HMI211RS in-home display, including pre-configured 12" harness

  HMI21 remote display, including pre-configured 12" harness

  HMI220 remote display, including pre-configured 12" harness

  HMI220 remote display, including pre-configured 12" harness
- Battery charger stand-alone, 12 V
   Circuit breakers
   Enclosure Sound Level 1 to Sound Level 2

AC protection

· Fail to start (overcrank) shutdow · Fail to crank shutdown · Redundant start disconnect Cranking lockout

3-phase AC current

- Alternator heater
   Maintenance and service kit
   Engine lift kit
   Various fuel tanks and accessories

### Control system PowerCommand 1.1





- PowerCommand control is an integrated generator set control system providing voltage regulation, engine protection, operator interface and isochronous governing (optional). Major features include:
- Battery monitoring and testing features and smart starting control system.
- control system.

  Standard PCCNet interface to devices such as remote annunciator for NFPA 110 applications.

  Control boards potted for environmental protection.

  Control boards potted for environmental protection.

- Prototype tested; UL, CSA, and CE compliant.

  InPower™ PC-based service tool available for detailed diagnostics.

  Operator/display panel

## Manual off switch

- Alpha-numeric display with pushbutton access for viewing engine and alternator data and providing setup, controls and adjustments (English or international symbols)

   Total kVa

   Total kVa

   Total kVa

   Display et al
- adjustments (English or international sympoles)

  LED lamps indicating generator set running, not in auto, common warning, common shutdown, manual run mode and remote start

  Suitable for operation in ambient temperatures from

## Other data

- · Generator set model data
- . Start attempts, starts, running hours Fault history
   RS485 Modbus® interface
- Data logging and fault simulat service tool)
- service tool)
  Digital governing (optional)
  Integrated digital electronic isochronous gove
  Temperature dynamic governing
  Digital voltage regulation
  Integrated digital electronic voltage regulator

- · 2-phase Line-to-Line sensing
- · Configurable torque matching
- Control functions Time delay start and cooldown
- Cycle cranking
   PCCNet interface
   (2) Configurable inputs
   (2) Configurable outputs
- Remote emergency stop
   Automatic Transfer Switch (ATS) control

Emergency Standby Power (ESP):

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DIN 8271 and 85 8514.

Applicable for supplying power continuous Power (COP):

Applicable for supplying power continuous Power (COP) in accordance with ISO 8528, ISO 3046, AS 2789, DIN 8271 and 85 8514.

- Options
   Auxiliary output relays (2) Remote annunciator with (3) configurable inputs and (4) configurable outputs
- PMG alternator excitation PowerCommand 500/550 for remote monitoring and alarm notification (accessory)
- Auxiliary, configurable signal inputs (8) and configurable relay outputs (8) Digital governing
   AC output analog meters (bargraph)
  - Color-coded graphical display of:
     3-phase AC voltage
  - 3-phase current - Frequency
  - Remote operator pane


## · Generator set exercise, field adjustable Ratings definitions

Applicable for supplying power to varying electrical load for the duration of power interruption of a reliable utility source. Emergency Standby Power (ESP) is in accordance with ISO 8528. Fuel Stop power in accordance with ISO 3046, AS 2789, DIN 6271 and BS 5514.

Limited-Time Running Power (LTP): Applicable for supplying power to a constant electr load for limited hours. Limited-Time Running Powe (LTP) is in accordance with ISO 8528.

(LTP) is in accordance with ISO 5528.

Prime Power (PRP):
Applicable for supplying power to varying electrical load for unlimited hours. Prime Power (PRP) is in accordance with ISO 8528. Ten percent overload capability is available in accordance with ISO 3046, AS 2789, DIN 8271 and 85 5514.

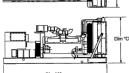

Do not use for installation design

	Dim "A"	Dim "B"	Dim "C"	Set weight*	Set weight*		
Model	mm (in.)	mm (in.)	mm (in.)	dry kg (lbs)	wet kg (lbs)		
Open set							
C25 D6	2224 (87.5)	864 (34)	1121 (44.13)	504 (1115)	525 (1161)		
C30 D6	2224 (87.5)	864 (34)	1121 (44.13)	533 (1178)	553 (1224)		
C35 D6	2224 (87.5)	864 (34)	1121 (44.13)	552 (1221)	573 (1267)		
C40 D6	2224 (87.5)	864 (34)	1121 (44.13)	566 (1252)	587 (1298)		
	Sc	ound attenuated	enclosure Level	1			
C25 D6	2384 (93.8)	864 (34)	1156 (45.5)	551 (1219)	572 (1265)		
C30 D6	2384 (93.8)	864 (34)	1156 (45.5)	580 (1282)	600 (1328)		
C35 D6	2384 (93.8)	864 (34)	1156 (45.5)	599 (1325)	620 (1371)		
C40 D6	2384 (93.8)	864 (34)	1156 (45.5)	613 (1356)	634 (1402)		
	Sc	ound attenuated	enclosure Level	2			
C25 D6	2629 (103.5)	864 (34)	1156 (45.5)	570 (1261)	591 (1307)		
C30 D6	2629 (103.5)	864 (34)	1156 (45.5)	599 (1324)	619 (1370)		
C35 D6	2629 (103.5)	864 (34)	1156 (45.5)	618 (1367)	639 (1413)		
C40 D6	2629 (103.5)	864 (34)	1156 (45.5)	632 (1398)	653 (1444)		

## Weights represent a set with standard features. See outline drawings for weights of other configurations.

## Codes and standards

Codes or standards comp	niance may not be available with all	model configurations – co	nsult factory for availability.
<u> 180 9001</u>	This generator set is designed in facilities certified to ISO 9001 and manufactured in facilities certified to ISO 9001 or ISO 9002.	(UL)	The generator set is available Listed to UL 2200, Stationary Engine Generator Assemblies.
	The Prototype Test Support (PTS) program verifies the performance integrity of the generator set design. Cummins products bearing the PTS symbol meet the prototype test requirements of NFPA 110 for Level 1 systems.	U.S. EPA	Engine certified to U.S. EPA SI Stationary Emission Regulation 40 CFR, Part 60.
<b>(</b>	All low voltage models are CSA certified to product class 4215-01.	International Building	The generator set is certified for seismic application in accordance with International

Warning: Back feed to a utility system can cause electrocution and/or property damage. Do not connect to any building's electrical system except through an approved device or after building main switch is open.

For more information contact your local Cummins distributor or visit power.cummins.com

## Our energy working for you.™

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NAS-SRF2-ENDOX (819) ASSGSQX.



**AMERICAN TOWER®** 

ATC TOWER SERVICES, LLC 3500 REGENCY PARKWAY SUITE 100 **CARY, NC 27518** PHONE: (919) 468-0112 COA: 24GA28099400



REV.	DESCRIPTION	BY	DATE
$\triangle_{-}$	PRELIM	RW	01/25/21
B_	REVISED PER COMMENTS	JPB	03/12/21
<u></u>	FINAL	TMM	09/01/21
$\overline{\wedge}$			
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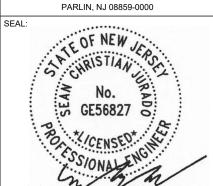
ATC SITE NUMBER 373155

ATC SITE NAME: PARLIN - SAYREVILLE

AT&T MOBILITY SITE NAME:

SITE ADDRESS: 775 WASHINGTON ROAD

PARLIN - NYCWNJ5836






DATE DRAWN: 01/20/21 ATC JOB NO: 13325346 G2 CUSTOMER ID: NWL05836 CUSTOMER #: 14652316


> **GENERATOR SPECIFICATIONS**

SHEET NUMBER:

C-505

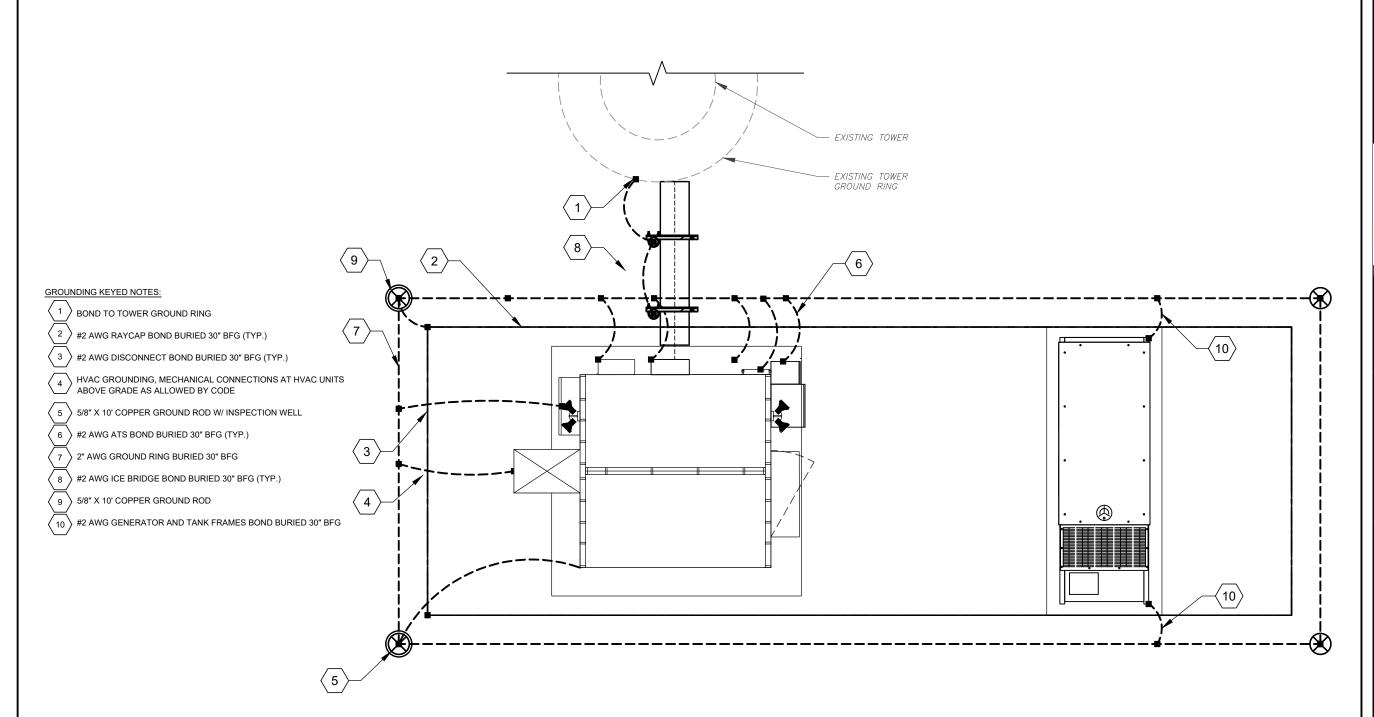


**DETAILED GROUNDING LAYOUT** SCALE: NOT TO SCALE

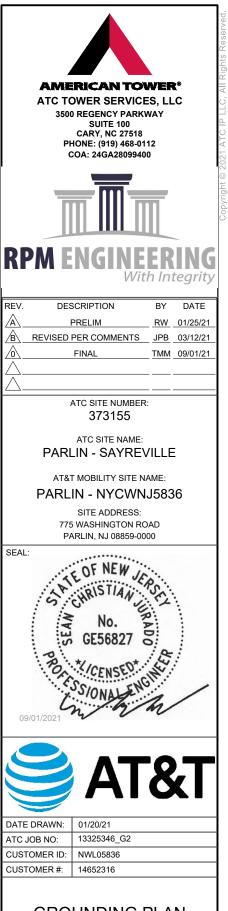



SHEET NUMBER:

E-101

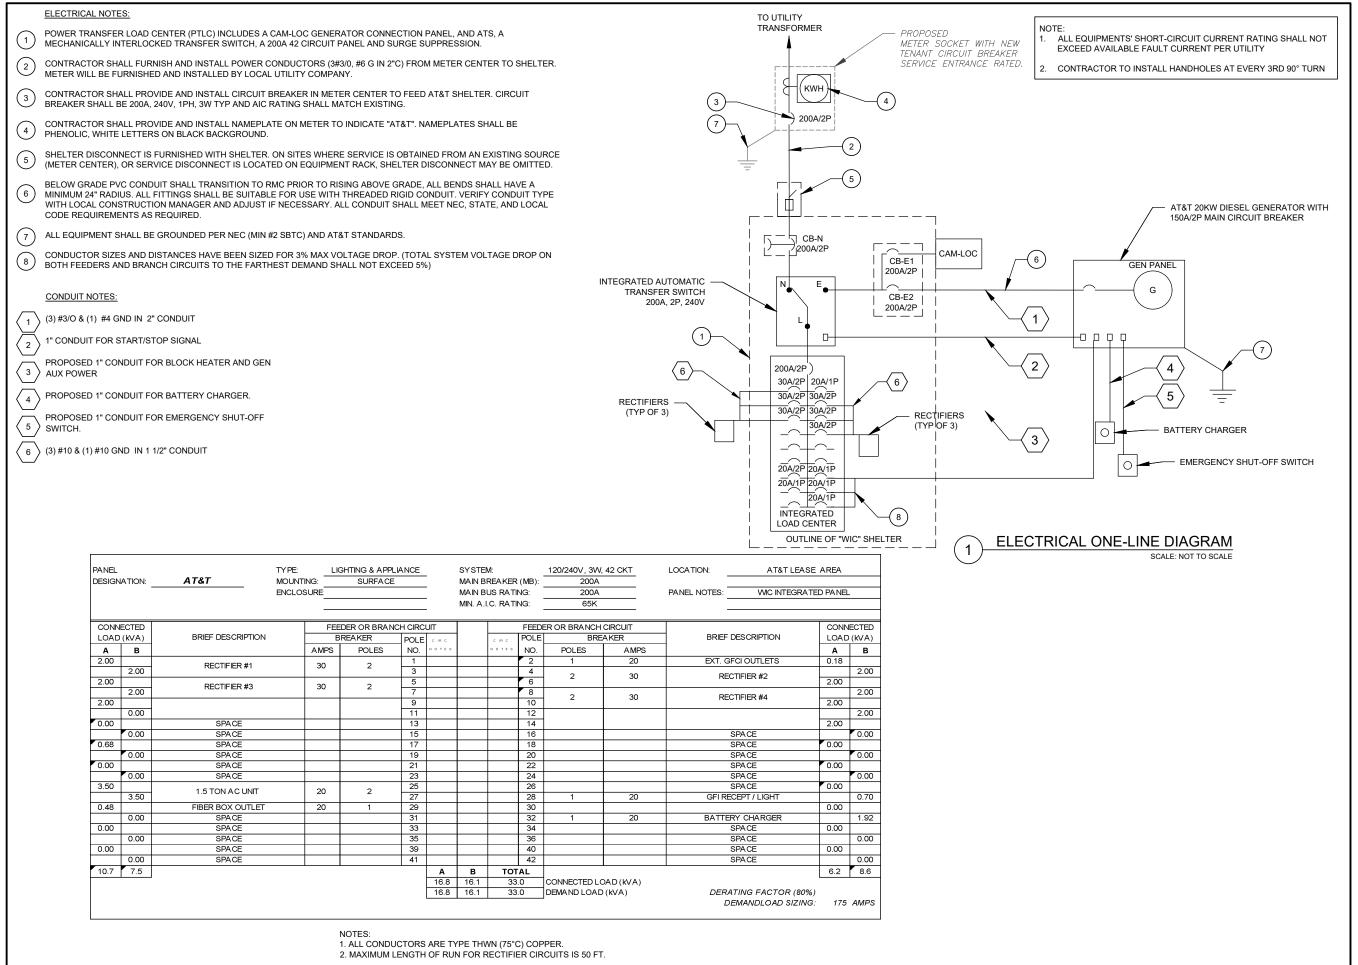





Kř	M ENGINE Wit	<b>LK</b> h In	<b>ING</b> tegrity
REV.	DESCRIPTION	BY	DATE
$\triangle_{-}$	PRELIM	RW	01/25/21
B\_	REVISED PER COMMENTS	JPB	03/12/21
<u></u>	FINAL	TMM	09/01/21


ATC SITE NUMBER: 373155

ATC SITE NAME:
PARLIN - SAYREVILLE

AT&T MOBILITY SITE NAME:

PARLIN - NYCWNJ5836

SITE ADDRESS: 775 WASHINGTON ROAD PARLIN, NJ 08859-0000

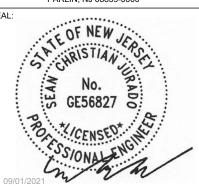




DATE DRAWN:	01/20/21
ATC JOB NO:	13325346_G2
CUSTOMER ID:	NWL05836
CUSTOMER #:	14652316

ELECTRICAL ONE-LINE & PANEL SCHEDULE


SHEET NUMBER

E-102

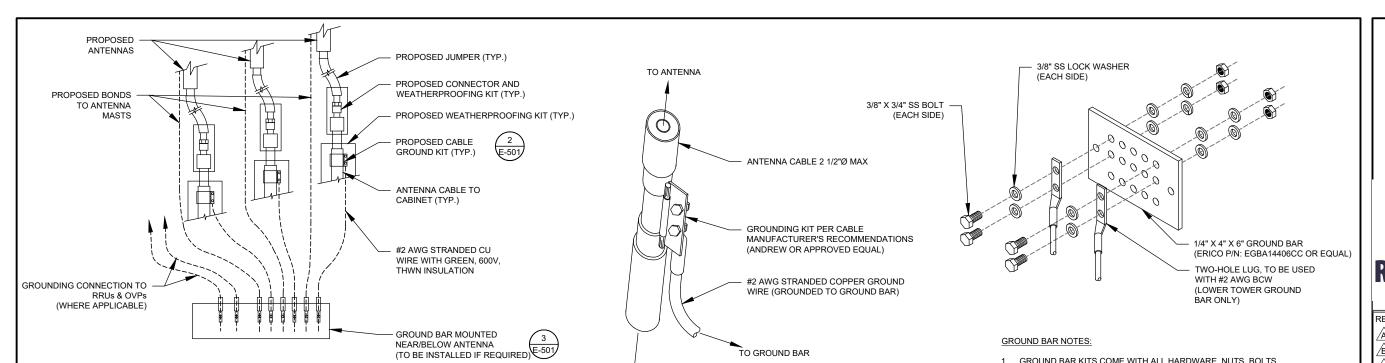

- THIS DETAIL IS INTENDED TO SHOW THE GENERAL GROUNDING REQUIREMENTS. SLIGHT ADJUSTMENTS MAY BE REQUIRED BASED ON EXISTING SITE CONDITIONS. THE CONTRACTOR SHALL MAKE FIELD ADJUSTMENTS AS NEEDED AND INFORM THE CONSTRUCTION MANAGER OF ANY CONFLICTS.
- SITE GROUNDING SHALL COMPLY WITH AT&T GROUNDING STANDARDS, LATEST EDITION, AND COMPLY WITH AT&T GROUNDING CHECKLIST, LATEST VERSION. WHEN NATIONAL AND LOCAL GROUNDING CODES ARE MORE STRINGENT THEY SHALL GOVERN.

## TYPICAL ANTENNA GROUNDING DIAGRAM

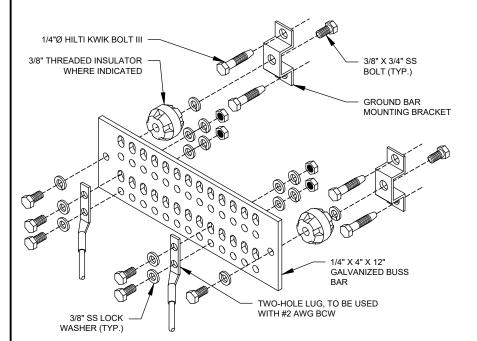

## **GROUND BAR NOTES**

- GROUND KITS COME WITH ALL HARDWARE, NUTS, BOLTS, WASHERS, ETC. EXCEPT THE STRUCTURAL MOUNTING MEMBER(S).
- 2. GROUND BAR SHALL BE BOLTED TO STRUCTURAL MEMBER OR ANCHORED TO CONCRETE SLAB W/ HILTI KWIK BOLT III.


TO EQUIPMENT


- GROUND KIT NOTES:

  1. DO NOT INSTALL CABLE GROUND KIT AT A BEND AND ALWAYS DIRECT GROUND WIRE DOWN TO GROUND BAR.
- 2. CONTRACTOR SHALL PROVIDE WEATHERPROOFING KIT (ANDREW PART NUMBER 221213) AND INSTALL/TAPE PER MANUFACTURER'S SPECIFICATIONS.

# CABLE GROUND KIT CONNECTION DETAIL

- SEPARATION DIMENSION TO BE VERIFIED WITH LOCAL UTILITY COMPANY
- 2. COORDINATE UTILITY, LOCATE BEFORE DIGGING.
- CONDUIT TRENCHING DEPTHS AT 36" OR 6" BELOW FROST LINE, WHICHEVER IS GREATER
- ALL RING AND RADIAL DEPTHS AT 30" OR 6" BELOW FROST LINE, WHICHEVER IS GREATER.

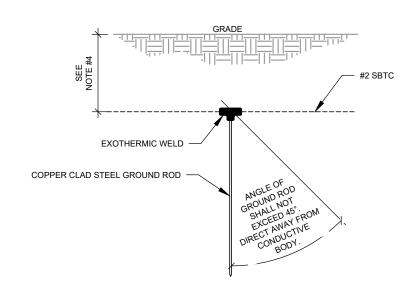

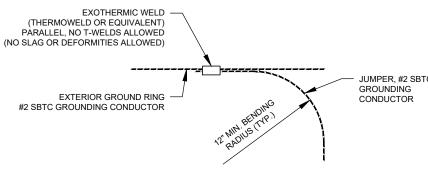

**GROUND ROD DETAIL** 

TIE CONNECTION DETAIL

- GROUND BAR KITS COME WITH ALL HARDWARE, NUTS, BOLTS, WASHERS, ETC. EXCEPT THE STRUCTURAL MOUNTING MEMBER(S).
- 2. GROUND BAR TO BE BONDED DIRECTLY TO TOWER.

## TOWER GROUND BAR DETAIL





**AMERICAN TOWER** 

ATC TOWER SERVICES, LLC

3500 REGENCY PARKWAY SUITE 100

**CARY, NC 27518** 

PHONE: (919) 468-0112

COA: 24GA28099400

DESCRIPTION

REVISED PER COMMENTS JPB 03/12/21

ATC SITE NUMBER: 373155

ATC SITE NAME:

PARLIN - SAYREVILLE

AT&T MOBILITY SITE NAME: PARLIN - NYCWNJ5836 SITE ADDRESS: 775 WASHINGTON ROAD PARLIN, NJ 08859-0000

RW 01/25/21

TMM 09/01/21


## **GROUNDING DETAILS**


SHEET NUMBER:

E-501

REVISION

MAIN GROUND BAR DETAIL SCALE: NOT TO SCALE

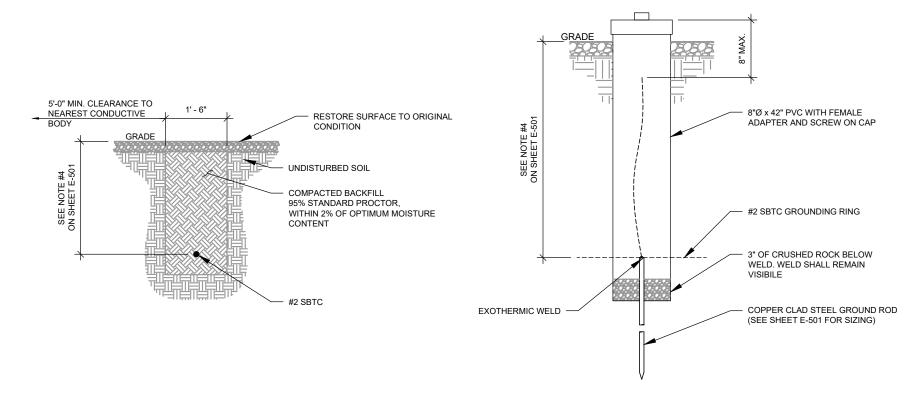

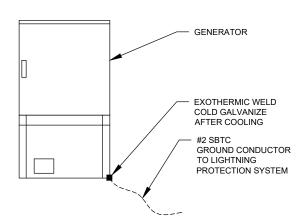

**TEST WELL DETAIL** 


SCALE: NOT TO SCALE

## GENERATOR INSTALLATION NOTE:

GROUND CONNECTION TRENCH DETAIL (STD.)

INSTALL GENERATOR AND TRANSFER SWITCH WITH ALL SUPPLIED ACCESSORIES PER MANUFACTURER'S INSTALLATION INSTRUCTIONS AND SPECIFICATIONS. THIS INCLUDES, BUT IS NOT LIMITED TO, ACCESSORIES FOR THE EXHAUST SYSTEM, FUEL SYSTEM, ENCLOSURE INTEGRITY (CAPS, PLUGS, COVERS, ETC.), ELECTRICAL CONNECTIONS, AND GROUNDING CONNECTIONS.



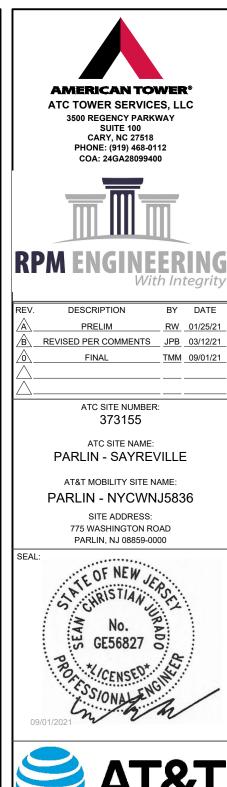




	DATE DRAWN:	01/20/21
	ATC JOB NO:	13325346_G2
	CUSTOMER ID:	NWL05836
	CUSTOMER #:	14652316

**GROUNDING DETAILS** 


SHEET NUMBER:

E-502

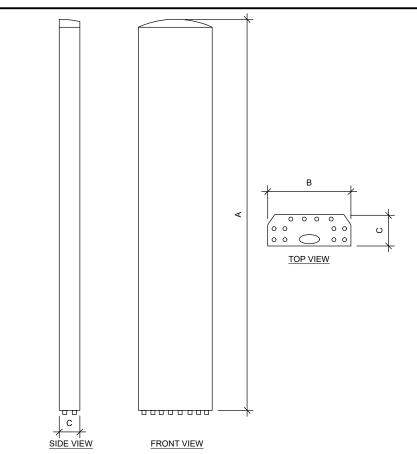

ANTENNA SPECIFICATIONS				
ANTENNA MODEL	А	В	С	WEIGHT (LBS)
COMMSCOPE NNHH-65B-R4	72"	19.6"	7.8"	78.3


1 ANTENNA SPECIFICATIONS
NOT TO SCALE

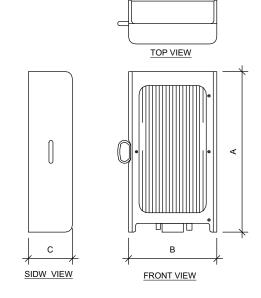



RRU SPECIFICATIONS					
RRU MODEL	А	В	С	WEIGHT (LBS)	
AIRSCALE TRI RRH 4T4R B12/14/29 370W AHLBBA	-	-	-	-	
AIRSCALE DUAL RRH 4T4R B25 / 66 320W AHFIB	22"	12.1"	5.9"	66.1	
AIRSCALE RRH 4T4R B5 160W AHCA	13.3"	11.6"	6.5"	35.3	
AIRSCALE RRH 4T4R B30 100W AHNA	13.3"	12.1"	5.5"	34.2	

2 RRU SPECIFICATIONS

NOT TO SCALE

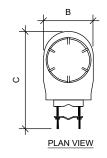

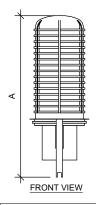

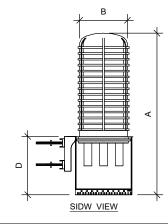

RAYCAP SPECIFICATIONS					
RAYCAP MODEL	Α	В	С	D	WEIGHT (LBS)
DC9-48-60-24-8C-EV	31.4"	10.2	18.3"	-	16

3 RAYCAP SPECIFICATIONS


NOT TO SCALE

SUPPLEMENTAL

SHEET NUMBER:

REVISION:


R-601

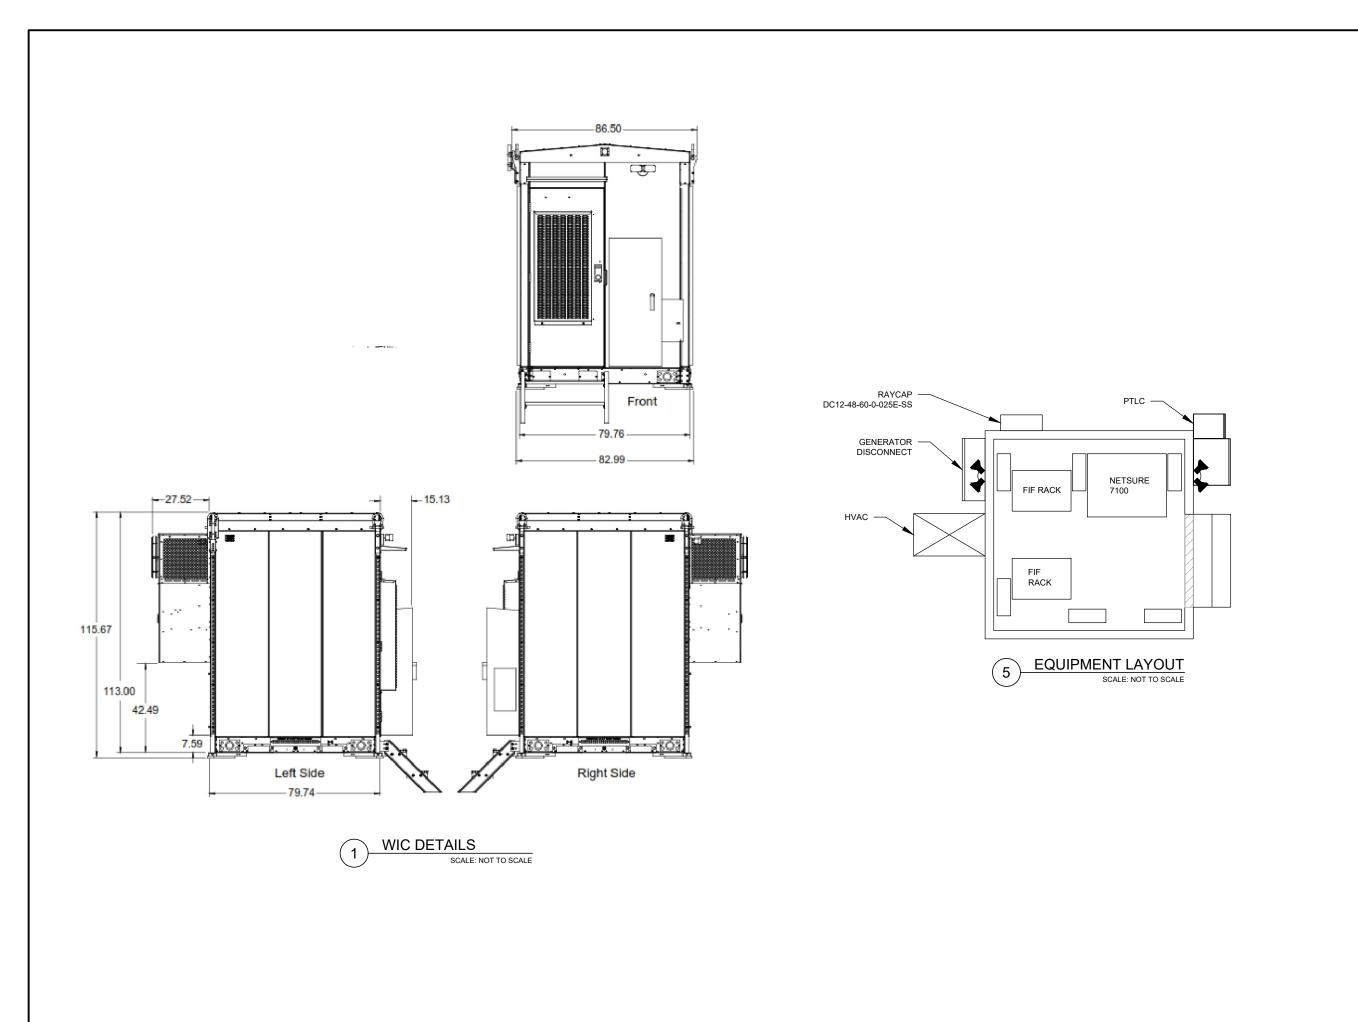

SUPPLEMENTAL

SHEET NUMBER: REVISION:

R-602

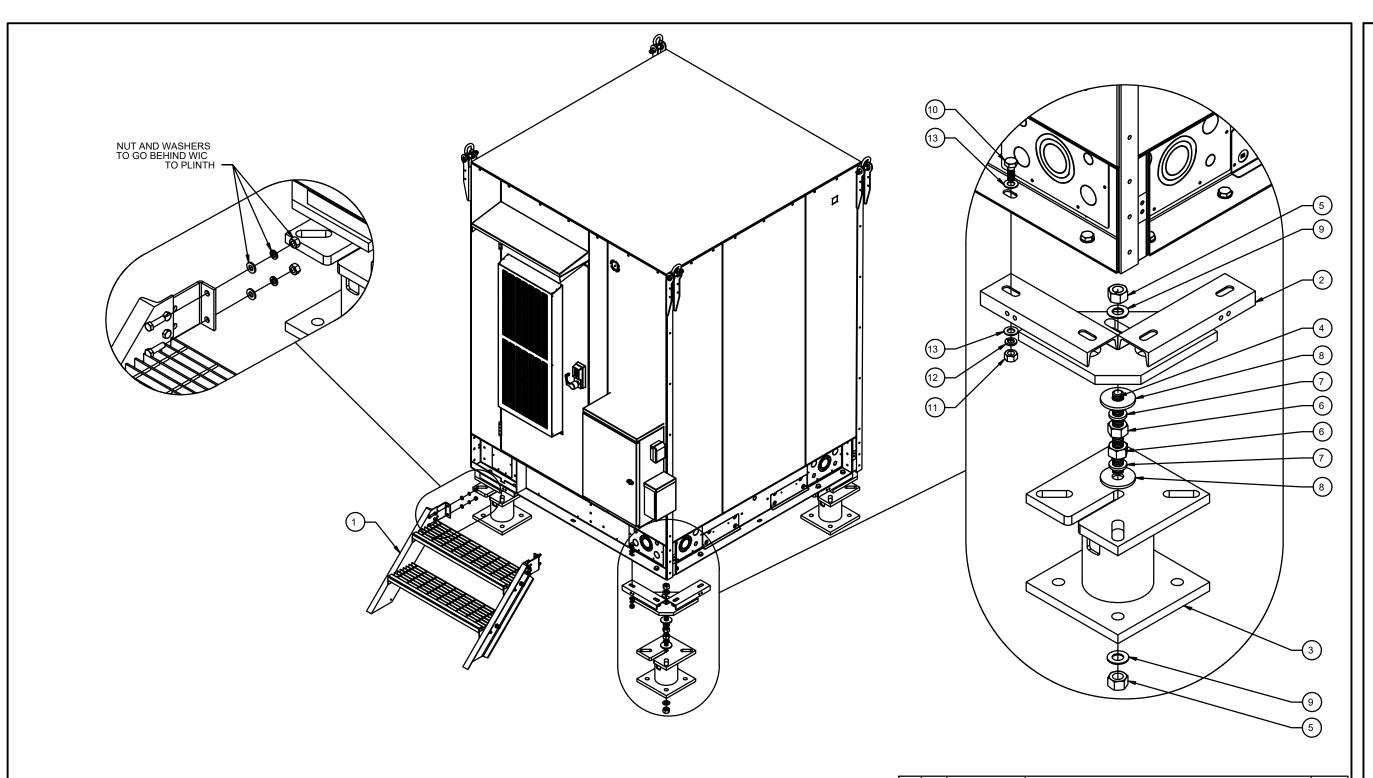

## NOTES:

- 1. WIC DETAIL BASED ON DRAWINGS BY VERTIV
- 2. ANCHOR WIC OR PLINTH W/ 1/2" HILTI TZ ANCHORS, EMBEDDED 3-3/4" WITH HILTI HY200 EPOXY ADHESIVE COMPOUND.
- GALVANIZED P1000 TO BE UTILIZED AT WIC FOR DC12, FMB & RRH'S. CAP ENDS & INSTALL PER MANUFACTURER RECOMMENDATIONS.

ITEM NO.	QTY.	PART NUMBER	DESCRIPTION	WEIGHT
1	1	1003-0000-0016	WIC 2-STEP STAIRS KIT, 45 DEGREE	102.9
2	4	W-000-771	ATT WIC HELICAL ADAPTER WELDMENT	44.9
3	4	W-000-847	6" X 11" EXTENSION WELDMENT	81.5
4	4	002-0AT-H000	ROD, THREADED, 1.00"-8 X 9.00" LG, ASTM A193 B7, GALV	1.60
5	8	002-0NG-0000	NUT, HX, ANCO LOCK, 1.00-8UNC, GR 2H, GALV	0.43
6	8	002-0NG-0008	NUT, HX, 1.00"-8UNC, GR 2H, GALV	0.42
7	8	002-0LW-G008	WASHER, SPLIT LOCK, 1.00", GALV	0.09
8	8	002-0FW-G024	WASHER, FLAT, 1.063 ID, 3.25 OD, GALV	0.07
9	8	002-0FW-G009	WASHER, FLAT, 1.00", F436, GALV	0.08
10	16	002-0BG-0033	BOLT, HX HD, .625-11UNC X 1.75" LG, ASTM A325, GALV	0.03
11	16	002-0NG-0011	NUT, HX, .625-11UNC, GR DH, GALV	0.12
12	16	002-0LW-G004	WASHER, SPLIT LOCK, .625 INCH, GALV	0.03
13	32	002-0FW-G004	WASHER, FLAT, .625", ASTM F436, GALV	0.03

SUPPLEMENTAL

SHEET NUMBER:


R-603


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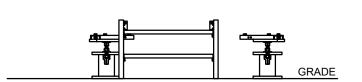
REVISION:


WIC SHELTER DETAILS

SCALE: NOT TO SCALE




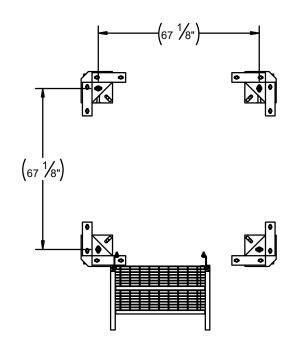

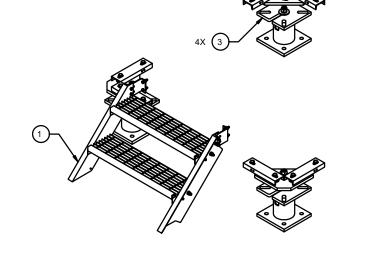

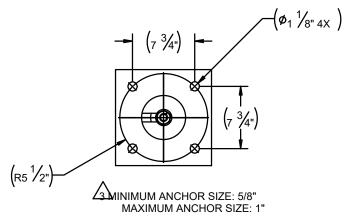



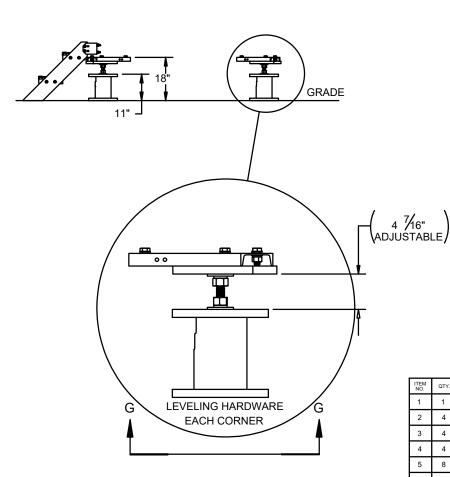

WIC SHELTER DETAILS

SCALE: NOT TO SCALE

## NOTES:

- 1. WIC DETAIL BASED ON DRAWINGS BY VERTIV
- 2. ANCHOR WIC OR PLINTH W/ 1/2" HILTI TZ ANCHORS, EMBEDDED 3-3/4" WITH HILTI HY200 EPOXY ADHESIVE COMPOUND.
- GALVANIZED P1000 TO BE UTILIZED AT WIC FOR DC12, FMB & RRH'S. CAP ENDS & INSTALL PER MANUFACTURER RECOMMENDATIONS.


ITEM NO.	QTY.	PART NUMBER	DESCRIPTION	WEIGHT
1	1	1003-0000-0016	WIC 2-STEP STAIRS KIT, 45 DEGREE	102.9
2	4	W-000-771	ATT WIC HELICAL ADAPTER WELDMENT	44.9
3	4	W-000-847	6" X 11" EXTENSION WELDMENT	81.5
4	4	002-0AT-H000	ROD, THREADED, 1.00"-8 X 9.00" LG, ASTM A193 B7, GALV	1.60
5	8	002-0NG-0000	NUT, HX, ANCO LOCK, 1.00-8UNC, GR 2H, GALV	0.43
6	8	002-0NG-0008	NUT, HX, 1.00"-8UNC, GR 2H, GALV	0.42
7	8	002-0LW-G008	WASHER, SPLIT LOCK, 1.00", GALV	0.09
8	8	002-0FW-G024	WASHER, FLAT, 1.063 ID, 3.25 OD, GALV	0.07
9	8	002-0FW-G009	WASHER, FLAT, 1.00", F436, GALV	0.08
10	16	002-0BG-0033	BOLT, HX HD, .625-11UNC X 1.75" LG, ASTM A325, GALV	0.03
11	16	002-0NG-0011	NUT, HX, .625-11UNC, GR DH, GALV	0.12
12	16	002-0LW-G004	WASHER, SPLIT LOCK, .625 INCH, GALV	0.03
13	32	002-0FW-G004	WASHER, FLAT, .625", ASTM F436, GALV	0.03

**SUPPLEMENTAL** 

REVISION:

SHEET NUMBER:


R-604

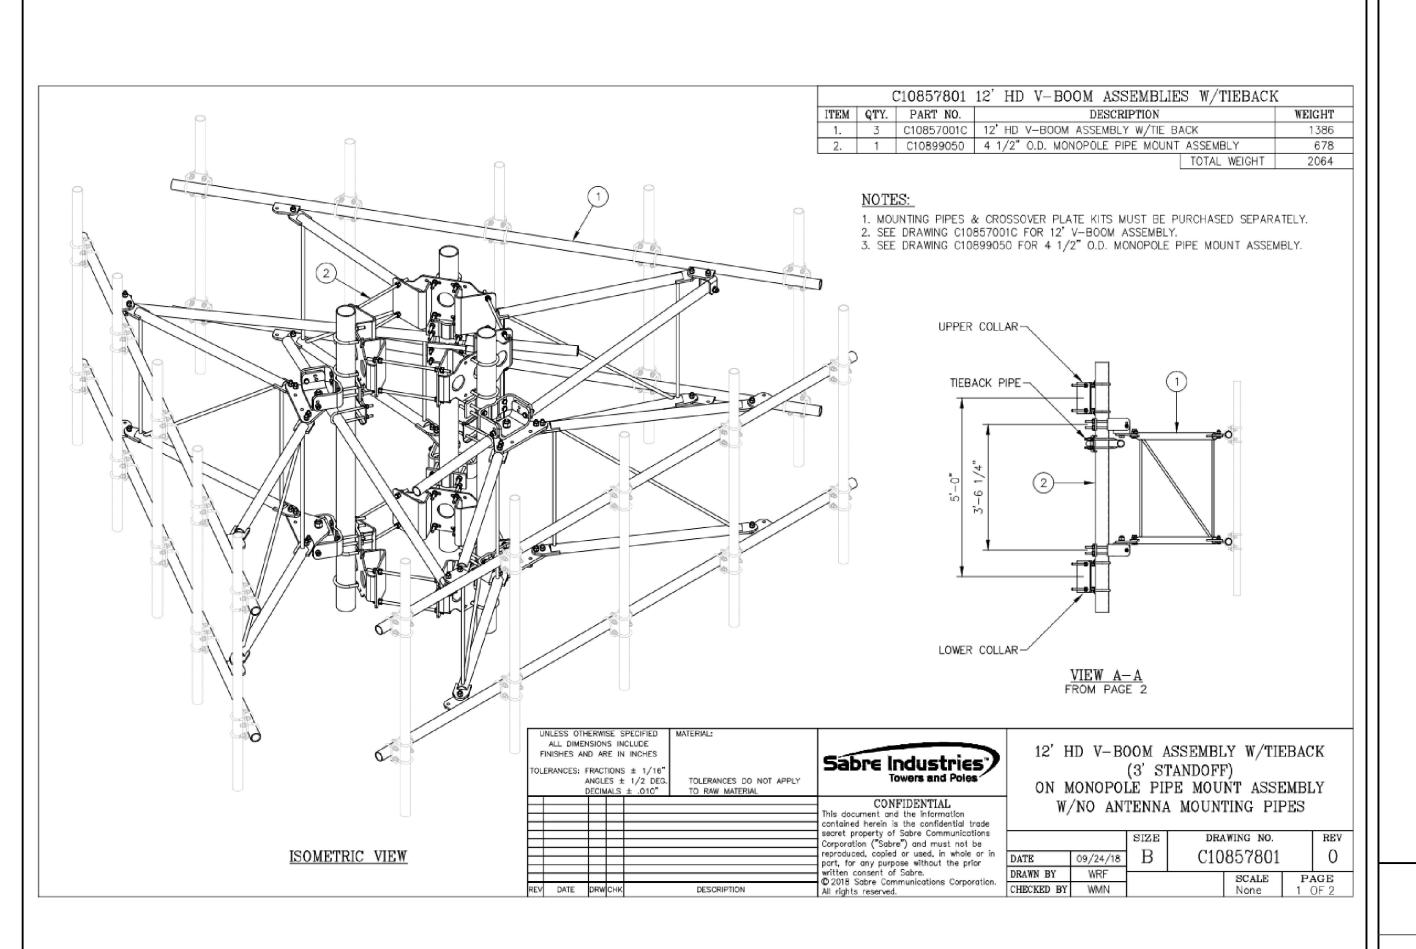

**SUPPLEMENTAL** 

SHEET NUMBER:

R-605

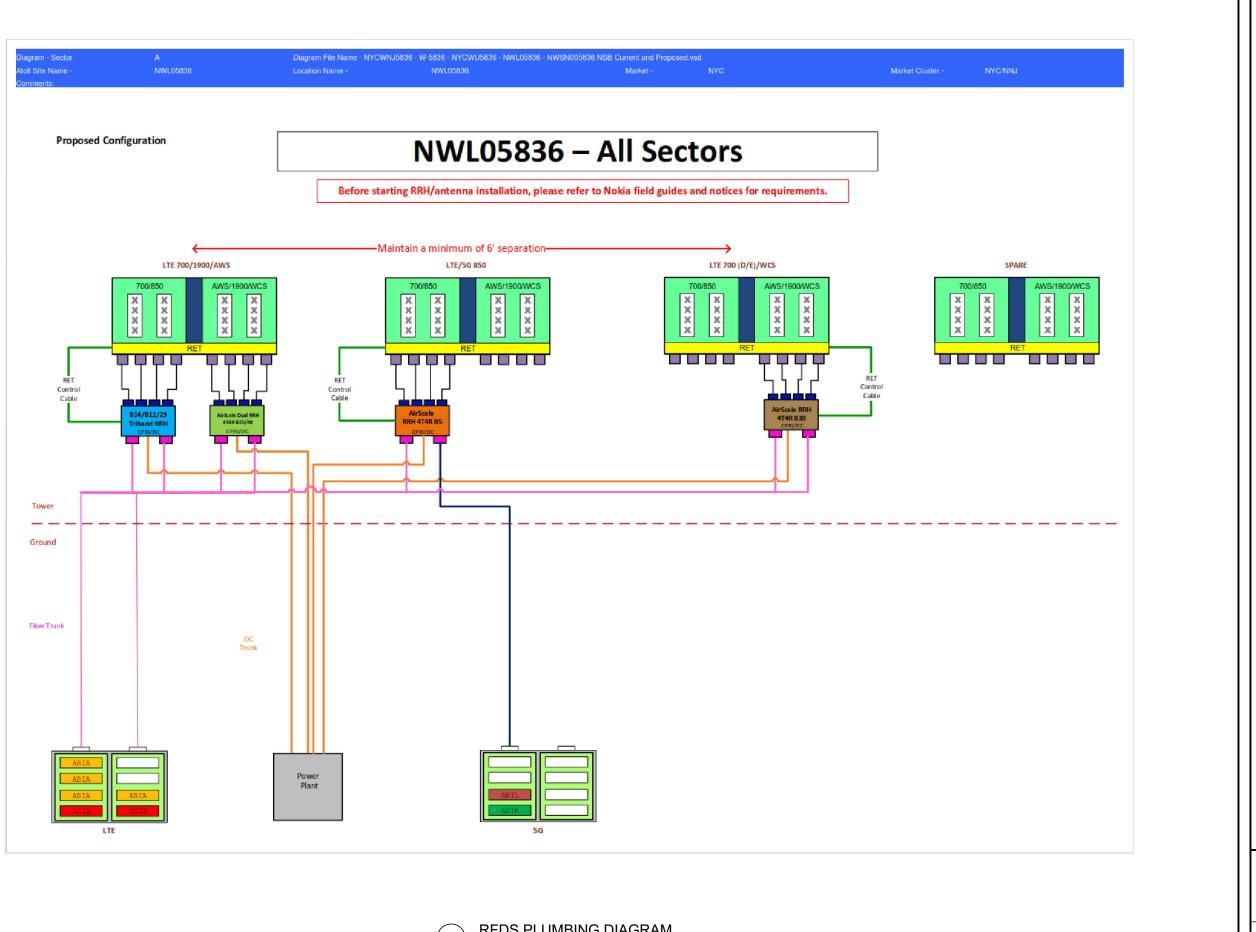

**SUPPLEMENTAL** SHEET NUMBER: REVISION: R-606

